


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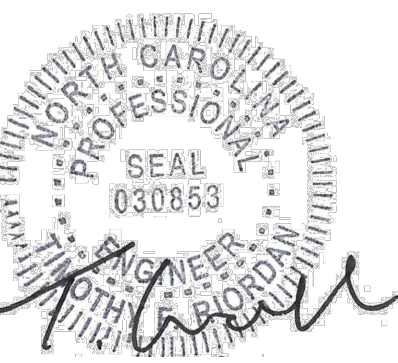
MARCH, 2025

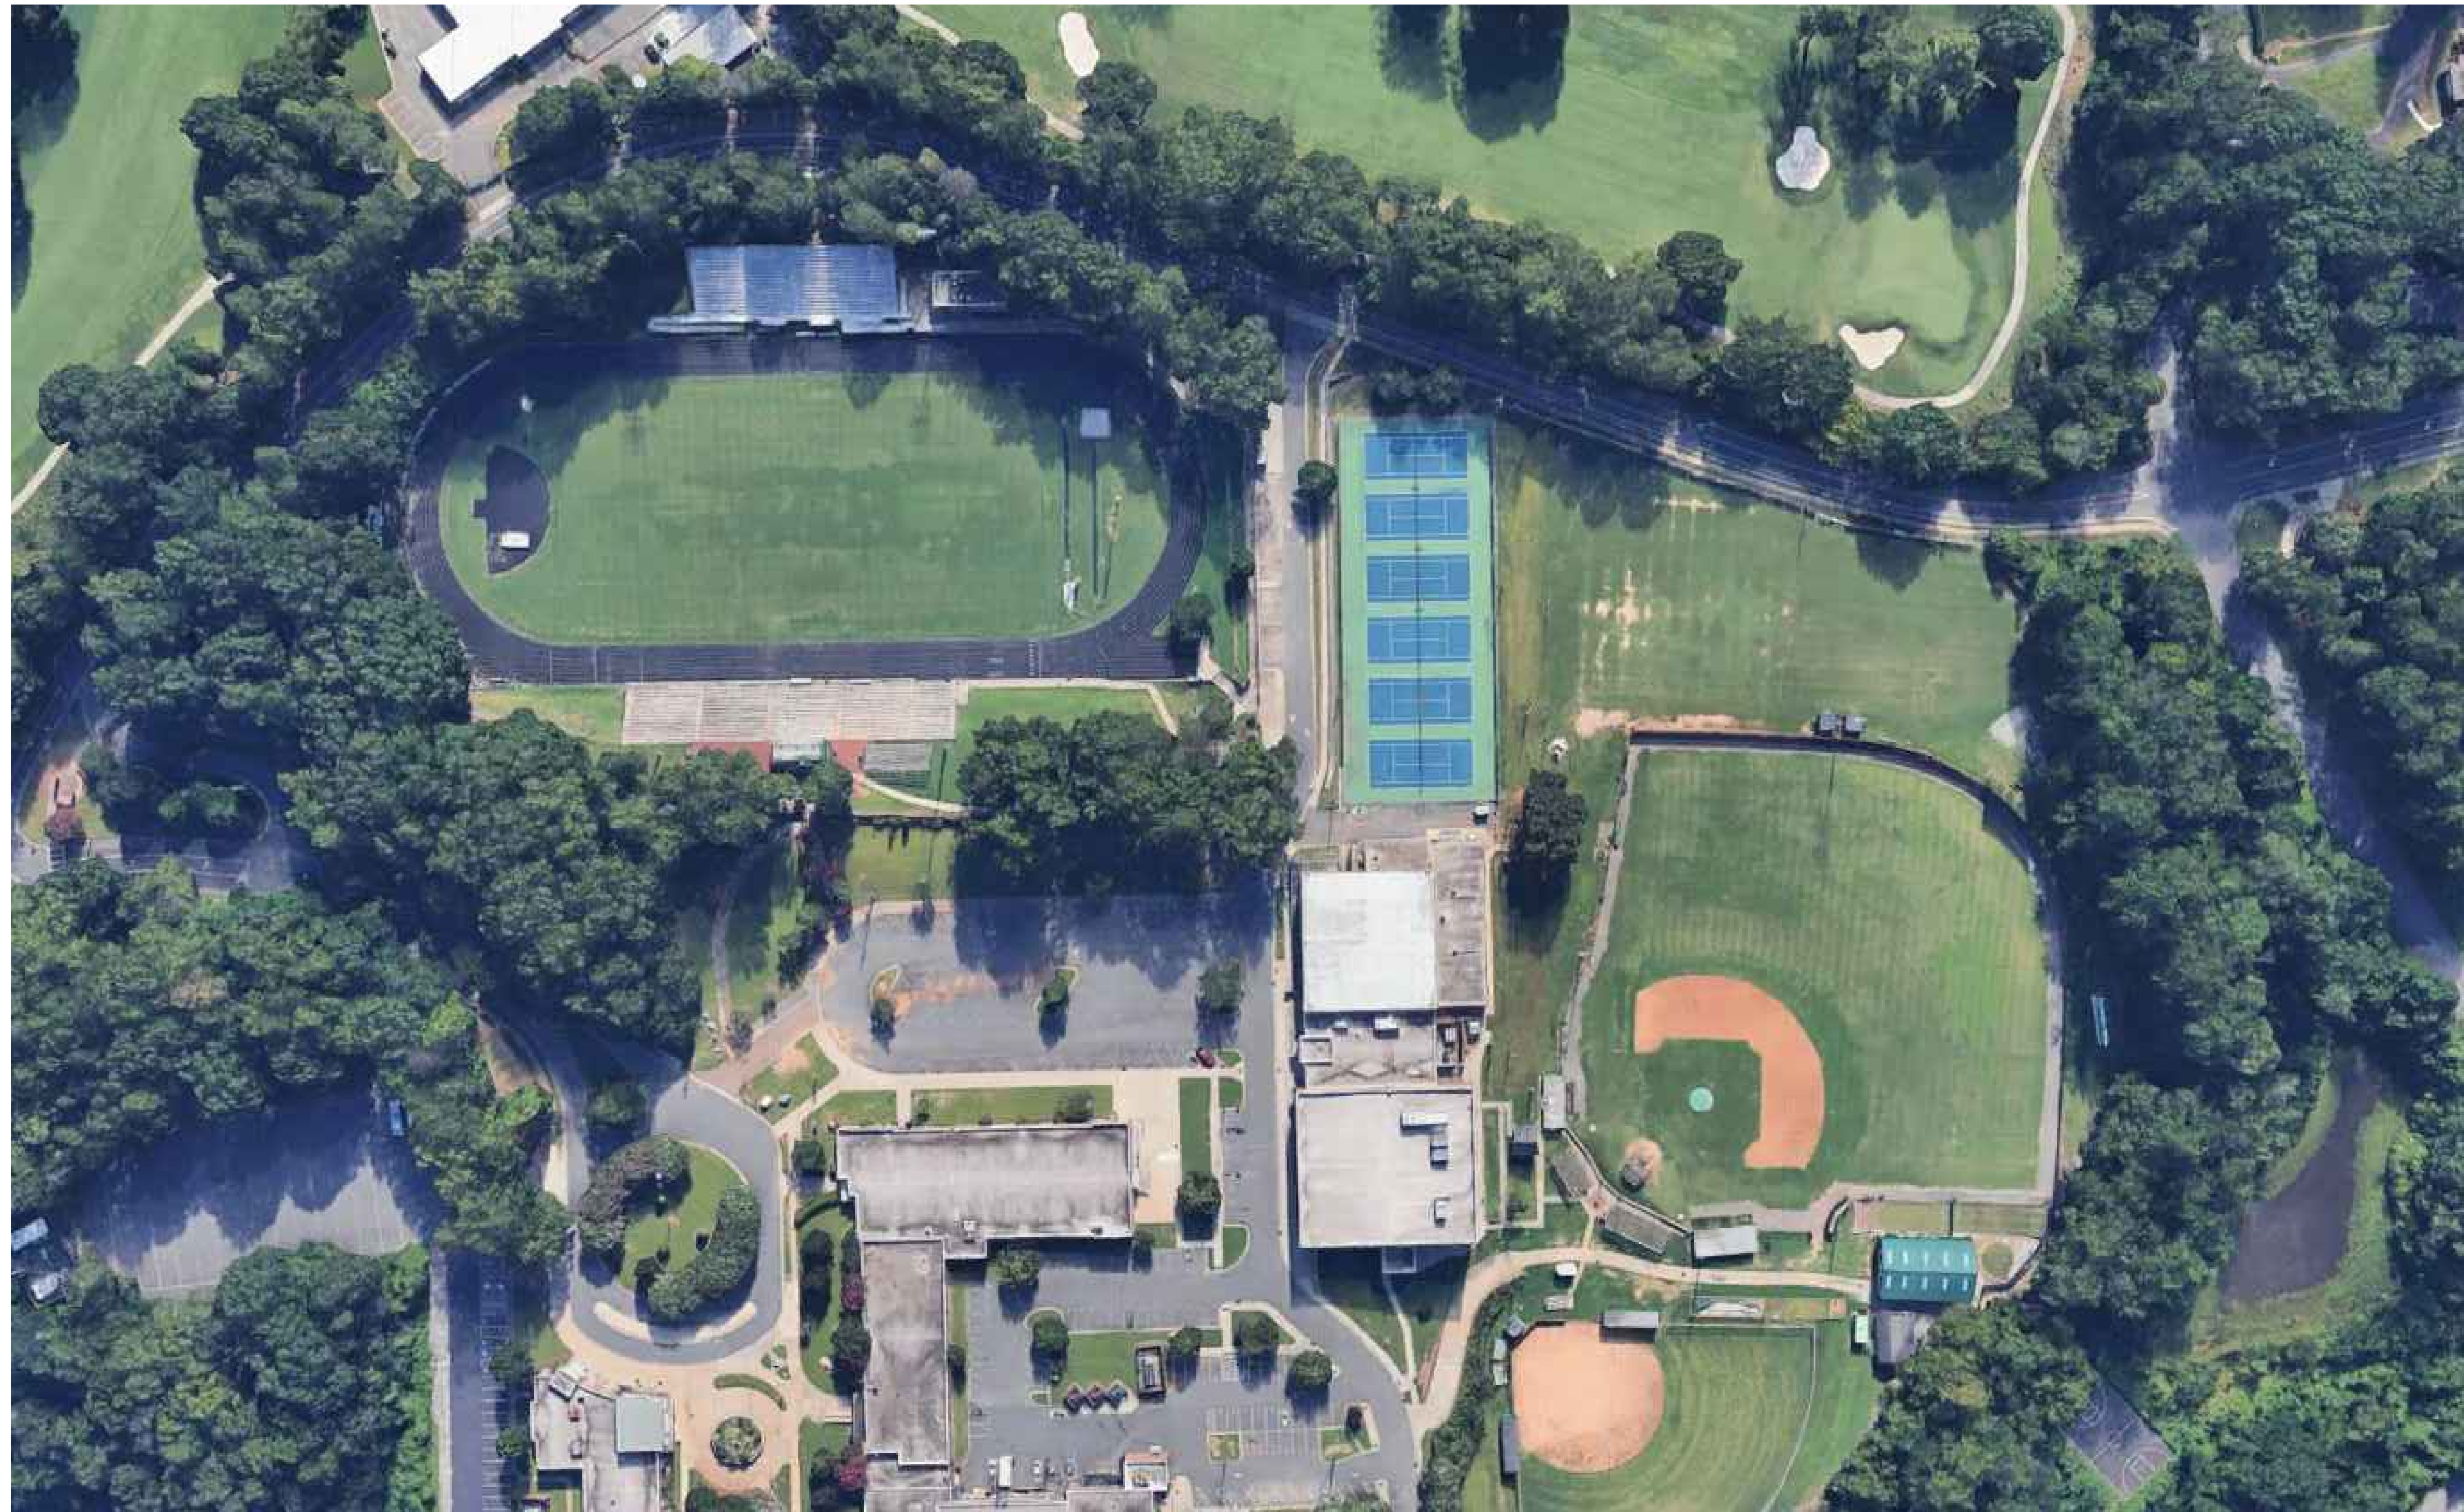

| SITE PLANS | |
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| Sheet Number | Sheet Title |
| G-000 | COVER SHEET |
| G-001 | GENERAL NOTES |
| C-000 | EXISTING CONDITIONS - TRACK |
| C-001 | EXISTING CONDITIONS - THROWS |
| C-002 | DEMOLITION PLAN - TRACK |
| C-003 | DEMOLITION PLAN - THROWS |
| C-100 | LAYOUT PLAN - TRACK |
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| C-200 | GRADING PLAN - TRACK |
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| C-602 | SITE DETAILS |

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SCHOOL TRACK AND
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COVER SHEET

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| Designed By: TR | Drawn By: CL | Checked By: PG |
| Issue Date: 3/9/25 | Project No.: 97244.001 | Scale: AS SHOWN |

Drawing No.:

G-000

GENERAL NOTES

- IT IS THE CONTRACTOR'S RESPONSIBILITY TO EXAMINE ALL PLAN SHEETS AND SPECIFICATIONS, AND COORDINATE ALL WORK AS REQUIRED.
2. THE DIRECTOR'S REPRESENTATIVE SHALL BE NOTIFIED IN WRITING OF ANY CONDITIONS THAT VARY FROM THOSE SHOWN ON THE PLANS. THE CONTRACTOR'S WORK SHALL NOT VARY FROM THE PLANS WITHOUT THE EXPRESSED, WRITTEN APPROVAL OF THE DIRECTOR'S REPRESENTATIVE.
3. THE CONTRACTOR SHALL RESTORE LAWNS, DRIVEWAYS, CULVERTS, SIGNS AND OTHER PUBLIC OR PRIVATE PROPERTY DAMAGED OR REMOVED TO AT LEAST AS GOOD A CONDITION AS BEFORE BEING DISTURBED AS DETERMINED BY THE DIRECTOR'S REPRESENTATIVE. ANY DAMAGED TREES, SHRUBS, AND/OR HEDGES SHALL BE REPLACED AT THE CONTRACTOR'S EXPENSE.
4. THE CONTRACTOR IS INSTRUCTED TO COOPERATE WITH ANY AND ALL OTHER CONTRACTORS PERFORMING WORK ON THIS JOB SITE DURING THE PERFORMANCE OF THIS CONTRACT.
5. ALL WORK SHALL BE DONE IN STRICT COMPLIANCE WITH ALL APPLICABLE NATIONAL, STATE, AND LOCAL CODES, STANDARDS, ORDINANCES, RULES, REGULATIONS, AND PERMITS.
6. THE CONTRACTOR SHALL PROTECT EXISTING PROPERTY LINE MONUMENTATION. ANY MONUMENTATION DISTURBED OR DESTROYED, INCLUDING MONUMENTS BY THE DIRECTOR'S REPRESENTATIVE, SHALL BE REPLACED AT THE CONTRACTOR'S EXPENSE UNDER THE SUPERVISION OF A STATE LICENSED LAND SURVEYOR.
7. THE DIRECTOR'S REPRESENTATIVE RESERVES THE RIGHT TO EXAMINE ANY WORK DONE ON THIS PROJECT AT ANY TIME TO DETERMINE THE CONFORMANCE WITH THE REQUIREMENTS OF THE CONTRACT DOCUMENTS OF THIS PROJECT, AS INTENDED AND INTERPRETED BY THE DIRECTOR'S REPRESENTATIVE.
8. MISCELLANEOUS WORK NOT SPECIFICALLY SHOWN ON THE CONTRACT DRAWINGS SUCH AS PATCHING, BLOCKING, TRIMMING, ETC., SHALL BE PERFORMED TO MAKE THE WORK COMPLETE.
9. THE CONTRACTOR SHALL:
- A. VERIFY ALL CONDITIONS IN THE FIELD PRIOR TO COMMENCEMENT OF WORK AND NOTIFY THE DIRECTOR'S REPRESENTATIVE OF ANY DISCREPANCIES.
 - B. EXAMINE THE SITE AND INCLUDE IN HIS WORK THE EFFECT OF ALL EXISTING CONDITIONS ON THE WORK.
 - C. PROVIDE AND INSTALL ALL MATERIALS AND PERFORM ALL WORK IN ACCORDANCE WITH RECOGNIZED GOOD STANDARD PRACTICE.
10. ALL TRENCH EXCAVATION AND ANY REQUIRED SHEETING AND SHORING SHALL BE DONE IN ACCORDANCE WITH THE LATEST REVISIONS OF THE STATE INDUSTRIAL CODE AND OSHA REGULATIONS FOR CONSTRUCTION. SHEET PILING SHALL BE DESIGNED AND SEALED BY A LICENSED PROFESSIONAL DIRECTOR'S REPRESENTATIVE.
11. THE CONTRACTOR SHALL MAINTAIN ACCESS TO ALL COMMERCIAL, AND PUBLIC PROPERTIES, AND AS DIRECTED BY THE DIRECTOR'S REPRESENTATIVE.
12. THE CONTRACTOR SHALL TAKE CARE TO PREVENT DAMAGE TO EXISTING UTILITIES. DAMAGED UTILITIES SHALL BE IMMEDIATELY REPAIRED BY THE CONTRACTOR AT THE CONTRACTOR'S EXPENSE.
13. THE CONTRACTOR SHALL TAKE CARE TO PREVENT DAMAGE TO EXISTING TREES THAT ARE TO REMAIN, ANY TREES DAMAGED AS A RESULT OF CONSTRUCTION ACTIVITY ARE TO BE REPLACED BY THE CONTRACTOR, IN KIND, AT THEIR EXPENSE.
14. ALL UTILITY WORK INVOLVING CONNECTIONS TO EXISTING SYSTEMS SHALL BE COORDINATED WITH THE DIRECTOR'S REPRESENTATIVE. NOTIFY THE DIRECTOR'S REPRESENTATIVE AT LEAST 72 HOURS PRIOR TO EACH AND EVERY CONNECTION THAT IS MADE.
15. CONSTRUCTION OF ALL PROPOSED UTILITIES MUST BEGIN AT THIS POINT OF CONNECTION TO THE EXISTING UTILITY, OR AT THE LOWEST POINT IN THE SYSTEM, RIMS, GRATES, INVERTS, CLEARANCES AND LOCATIONS AT CROSSINGS MUST BE VERIFIED PRIOR TO THE COMMENCEMENT OF CONSTRUCTION.
16. THE PLANS SHOW SUBSURFACE STRUCTURES, ABOVE-GROUND STRUCTURES AND/OR UTILITIES FROM FIELD LOCATION AND RECORD MAPPING, EXACT LOCATION OF WHICH MAY VARY FROM THE LOCATIONS INDICATED. IN PARTICULAR, THE CONTRACTOR IS WARNED THAT THE EXACT OR EVEN APPROXIMATE LOCATION OF SUCH PIPELINES, SUBSURFACE STRUCTURES AND/OR UTILITIES NOT SHOWN ON THE PLANS MAY BE DIFFERENT FROM THE ACTUAL LOCATION. THE CONTRACTOR SHALL BE RESPONSIBLE TO PROCEED WITH GREAT CARE IN EXAMINING ANY WORK. 72 HOURS BEFORE YOU DIG OR DRILL, CALL DIG SAFE ☎ 1-800-962-7962.

GENERAL SITE REMOVAL NOTES

1. ALL ORGANIC CONSTRUCTION DEBRIS SHALL BE DISPOSED OF OFF-SITE IN A LEGAL MANNER, AT THE CONTRACTOR'S EXPENSE.
2. THE CONTRACTOR SHALL EXERCISE CARE DURING REMOVAL OPERATIONS. ANY ITEMS INDICATED TO REMAIN THAT ARE DAMAGED DURING REMOVAL OPERATIONS SHALL BE REPAIRED OR REPLACED IN KIND, BY THE CONTRACTOR, AT NO COST TO THE OWNER.
3. ALL TOPSOIL TO REMAIN ON SITE, UNLESS OTHERWISE NOTED OR AS NECESSARY PER GRADING REQUIREMENTS.

GENERAL SITE LAYOUT NOTES

1. THE CONTRACTOR SHALL BE RESPONSIBLE FOR PROVIDING ALL CONSTRUCTION LAYOUT. THE CONTRACTOR SHALL MAKE TIES TO ALL UTILITY CONNECTIONS AND PROVIDE AS-BUILT PLANS FOR ALL UTILITIES SHOWING TIES TO EXISTING CONDITIONS, VALVE LOCATIONS, DEPT. OF PWS, AND INVERTS. AS-BUILT PLANS SHOWING ALL UNDERGROUND UTILITIES INSTALLED. UNACCOUNTED SHOWN SHALL BE REVIEWED BY THE DIRECTOR'S REPRESENTATIVE. THE CONTRACTOR SHALL PROVIDE ANY CORRECTIONS OR ADDITIONS TO THE SATISFACTION OF THE DIRECTOR'S REPRESENTATIVE BEFORE UTILITIES WILL BE ACCEPTED.
2. THE CONTRACTOR SHALL PROVIDE SMOOTH TRANSITIONS BETWEEN NEW WORK AND EXISTING CONDITIONS.
3. ALL ANGLES ARE 90°, UNLESS OTHERWISE INDICATED.

GENERAL SITE GRADING NOTES


2. PROPOSED GRADES SHALL BLEND SMOOTHLY WITH EXISTING ELEVATIONS.
3. THE CONTRACTOR SHALL STAKE OUT ALL GRADES IN THE FIELD PRIOR TO CONSTRUCTION AND NOTIFY THE DIRECTOR'S REPRESENTATIVE IN WRITING OF ANY DISCREPANCIES. THE DIRECTOR'S REPRESENTATIVE SHALL APPROVE STAKED GRADES.
4. THE CONTRACTOR SHALL BE RESPONSIBLE FOR DETERMINING AND THE MAINTENANCE OF SURFACE DRAINAGE DURING THE COURSE OF WORK. THE CONTRACTOR SHALL MAINTAIN EXISTING DRAINAGE PATTERNS THROUGHOUT THE PERIOD OF CONSTRUCTION.
5. ALL AREAS INDICATED TO RECEIVE SEED, SHALL BE DISCED AND HARROWED TO A DEPTH OF 4", AND FORMED TO PROVIDE SMOOTH TRANSITIONS WITH PROPOSED IMPROVEMENTS, PRIOR TO PLACEMENT OF SEED.

GENERAL EROSION CONTROL NOTES

1. SILTATION DEVICES SHALL BE INSTALLED PRIOR TO CLEARING AND GRUBBING.
2. SLOPES SHALL BE GRADED AT A MAXIMUM OF 3:1 WITHIN ALL CUT OR FILL AREAS.
3. TEMPORARY SEED SHALL BE A COMMERCIALY AVAILABLE MIXTURE OF PERENNIAL RYE AND UTILITY GRADE FESCUE. PERCENTAGE OF PERENNIAL RYE SHALL NOT EXCEED 50%. APPLICATION RATE SHALL BE 2.5 LBS PER 1,000 SF.
4. SEEDED AREAS SHALL BE FULLY COVERED WITH A LEAN STRAW OR MULCH MATERIAL. IF ORDERED BY THE DIRECTOR'S REPRESENTATIVE, A BIODEGRADABLE NETTING SHALL BE ANCHORED OVER SEEDED AREAS WHICH DEMONSTRATE "RILLING" OR OTHER EROSION PROCESSES.
5. SILTATION FENCE BARRIERS SHALL BE PLACED WITHIN ALL AREAS OF EXPOSED SLOPES TO CONTROL SOIL EROSION DURING AND AFTER CONSTRUCTION.
6. BARRIERS SHALL REMAIN IN PLACE UNTIL NEW SEEDING HAS SUFFICIENTLY GROWN TO STABILIZE COMPLETED EXTRA WORK.
7. MAINTENANCE PROGRAM: ALL EROSION CONTROL MEASURES ARE TO BE INSPECTED DAILY FOR PROPER FUNCTIONING. ANY NON-FUNCTIONING DEVICES SHALL BE REPLACED IMMEDIATELY. NO EROSION AND SEDIMENT CONTROL DEVICES SHALL BE REMOVED WITHOUT APPROVAL OF THE DIRECTOR'S REPRESENTATIVE.
8. CONTRACTOR TO FOLLOW EROSION CONTROL PROCEDURES DURING CONSTRUCTION AS OUTLINED IN THE SPECIFIC GUIDELINES FOR URBAN EROSION AND SEDIMENT CONTROL.
9. STORM INLET PROTECTION BARRIERS SHALL BE PLACED AROUND EACH CATCH BASIN OR DRY WELL GRATE TO PREVENT SILTATION.
10. IMMEDIATELY UPON COMPLETION OF GRADING, INSTALLATION OF END SECTIONS, SILT DIKES, SEDIMENT BARRIERS SHALL BE INSTALLED AS DETAILED. CONTRACTOR SHALL PERFORM INSTALLATION IN ANY AREA COMPLETED REGARDLESS OF STATE OF PROTECTION WITHIN BALANCE OF SITE.
11. ONCE PERMANENT EROSION AND SEDIMENT CONTROLS (I.E. SEEDING, PLANTING, ETC.) ARE FULLY ESTABLISHED, THE CONTRACTOR SHALL REMOVE AND DISPOSE OF ALL REMAINING TEMPORARY MEASURES.


GENERAL LANDSCAPE PLANTING NOTES

1. ALL AREAS OF THE SITE WHICH ARE DISTURBED AND NOT PLANTED, MULCHED, PAVED, ETC. SHALL BE TOPSOILED AND SEEDED. APPROVED TOPSOIL TO BE INSTALLED TO A MINIMUM 6" DEPTH.

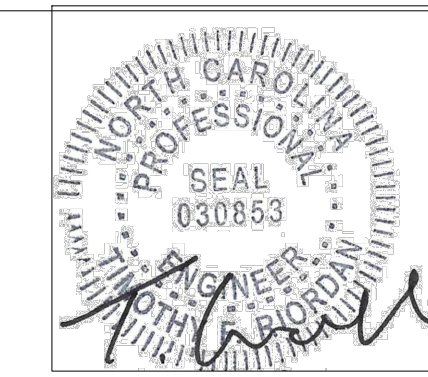

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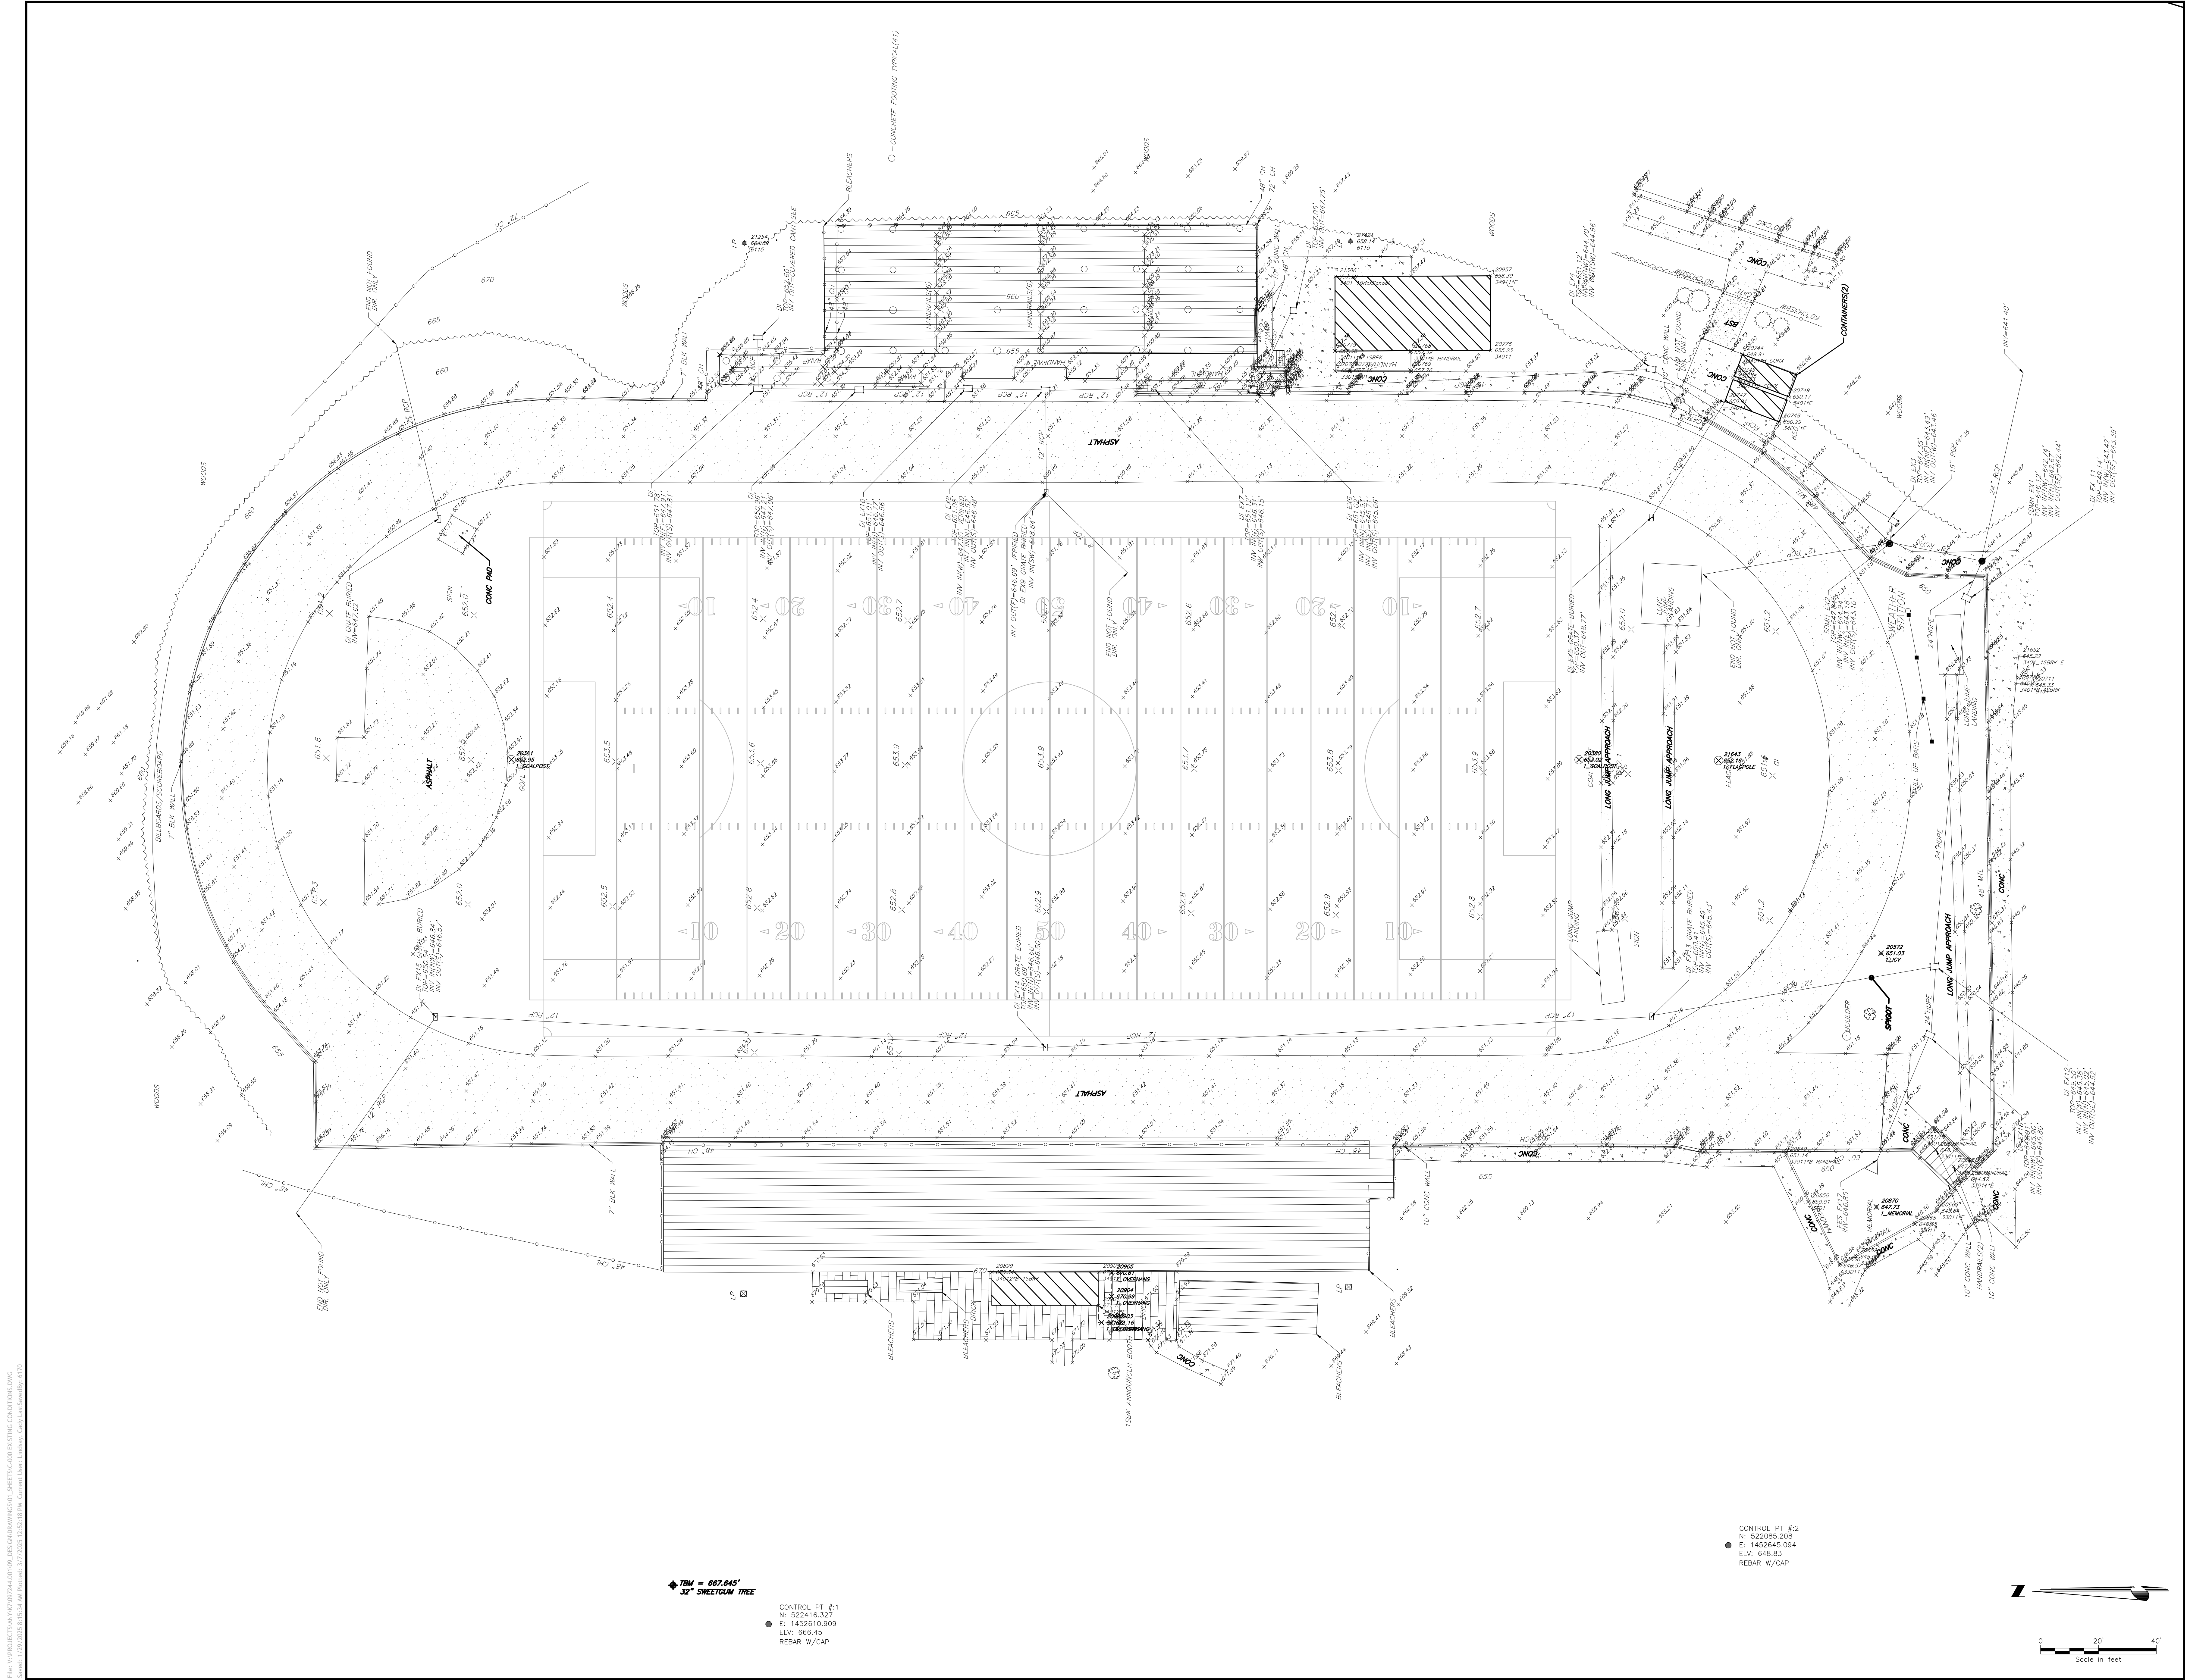
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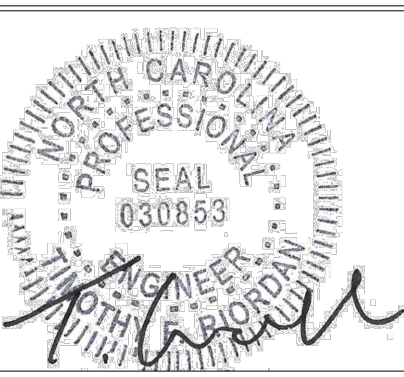
EXISTING
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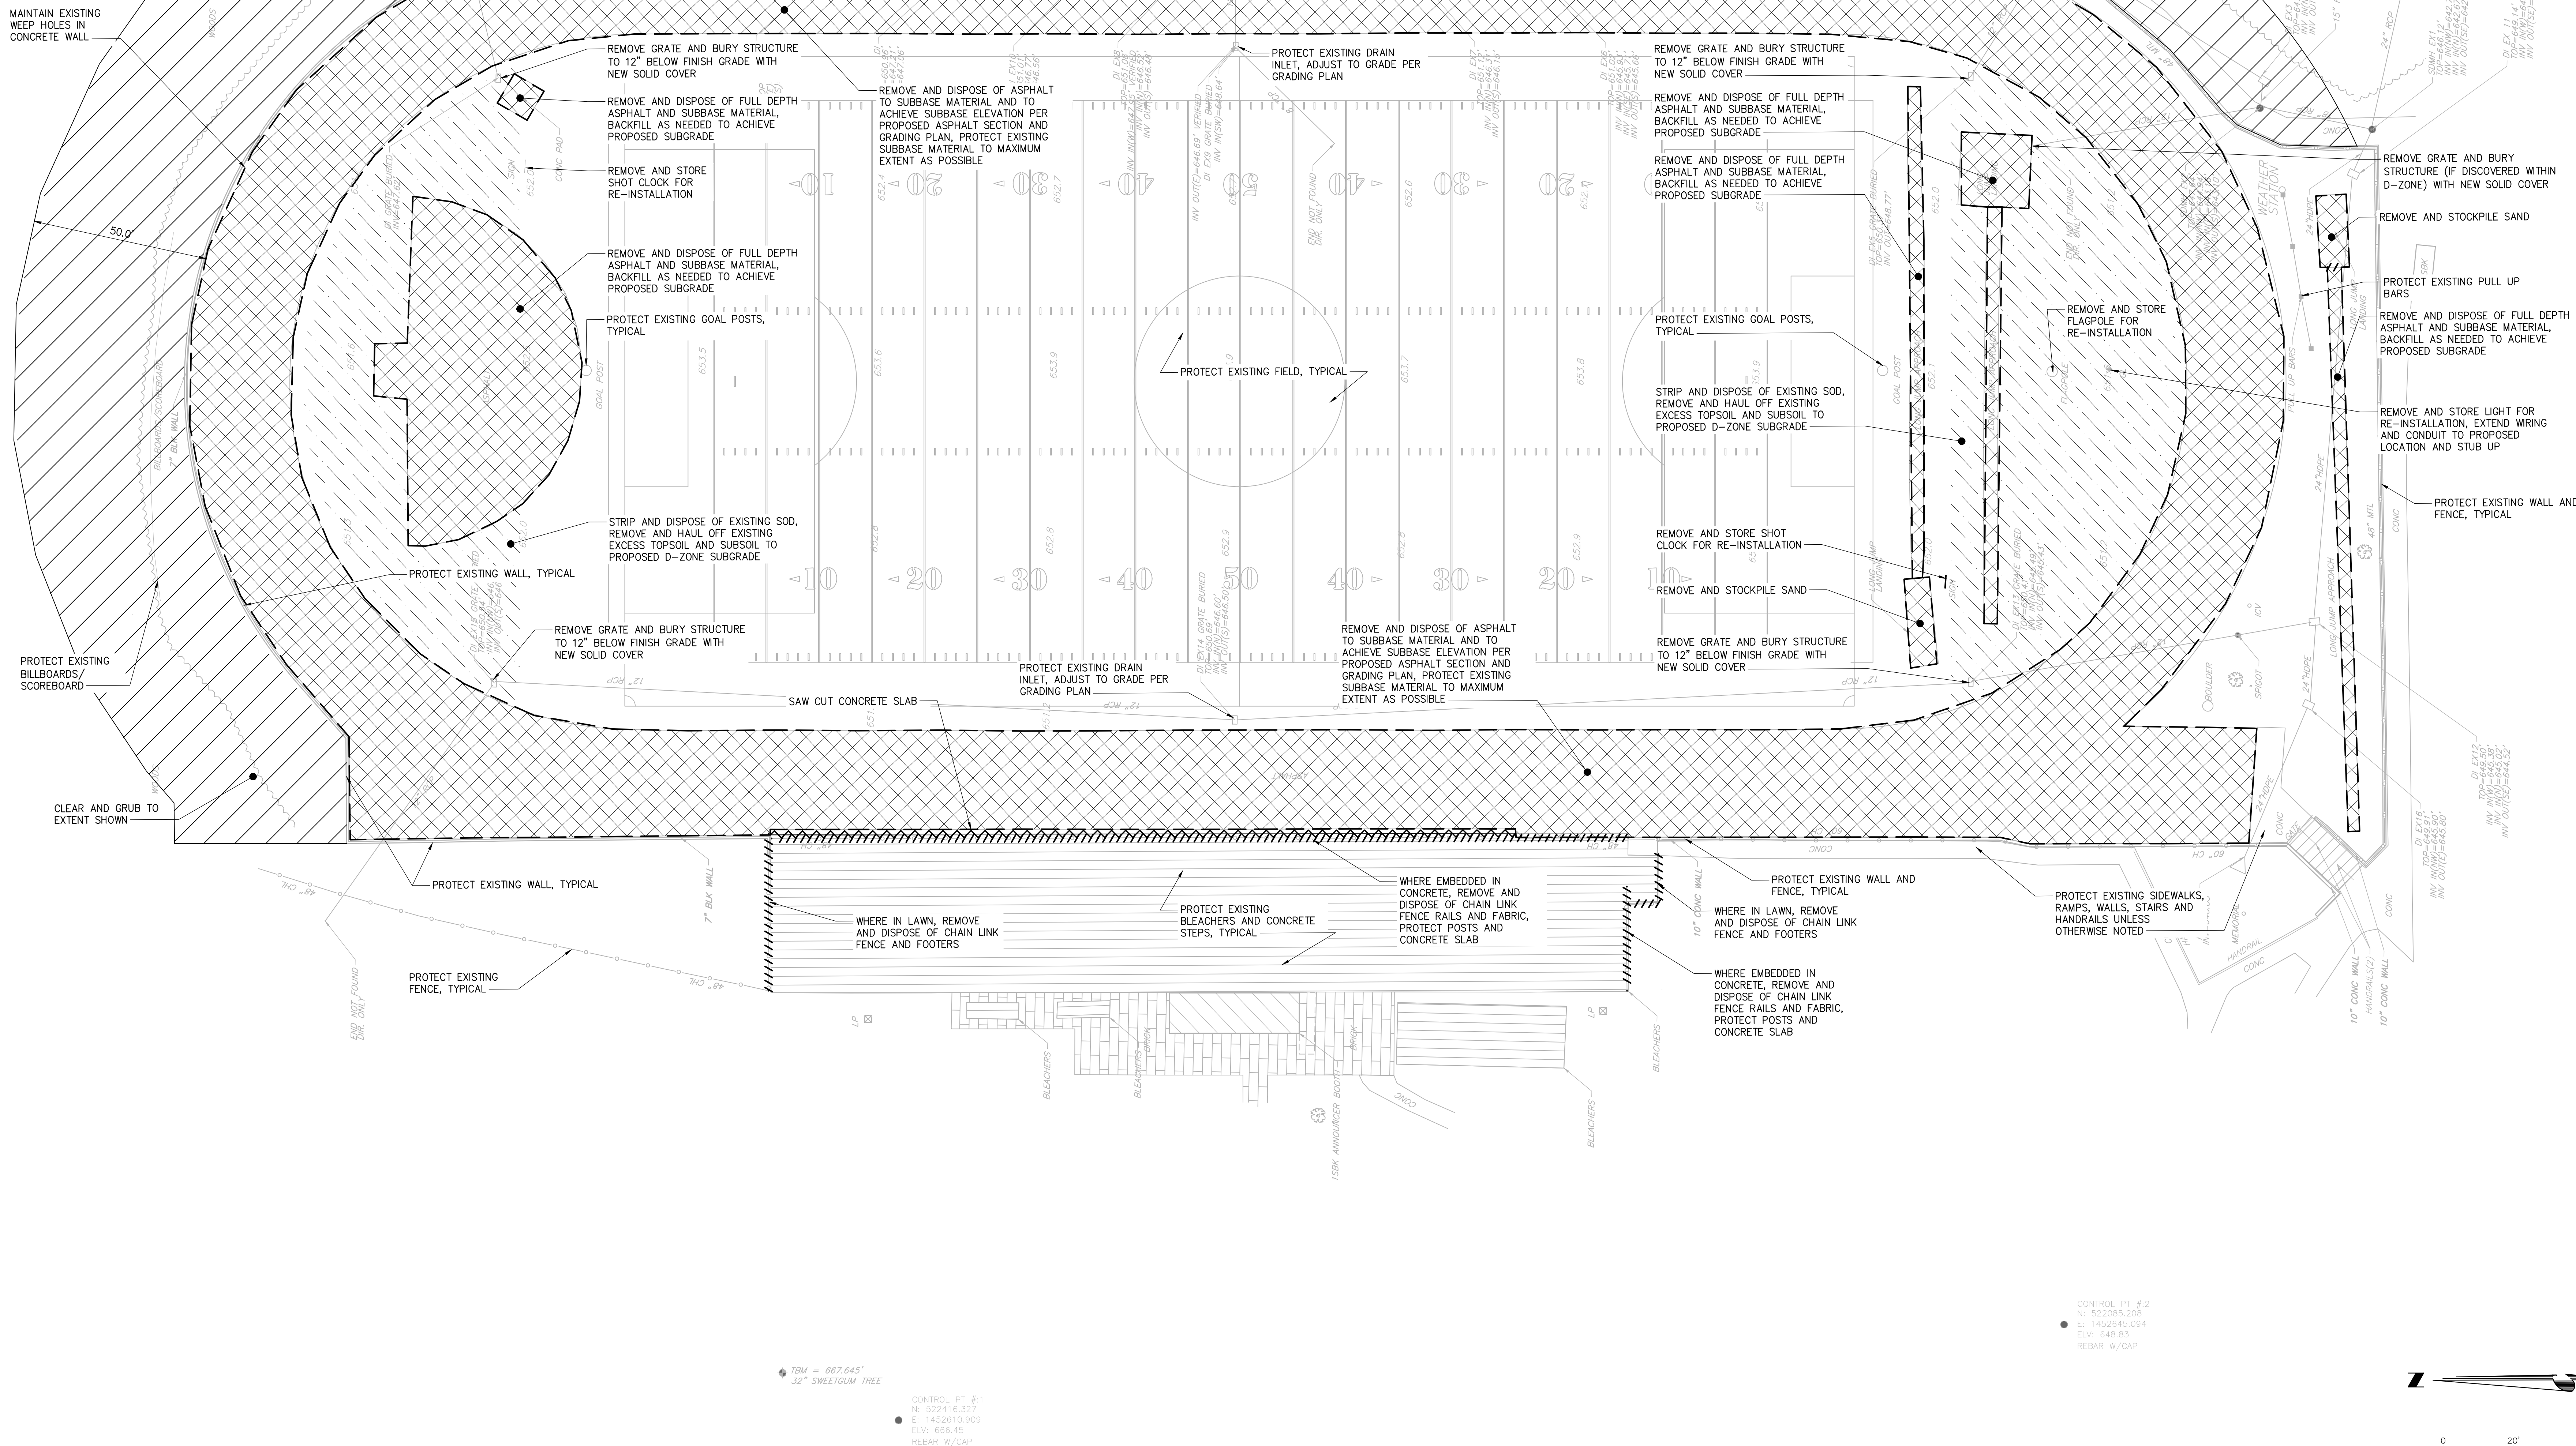
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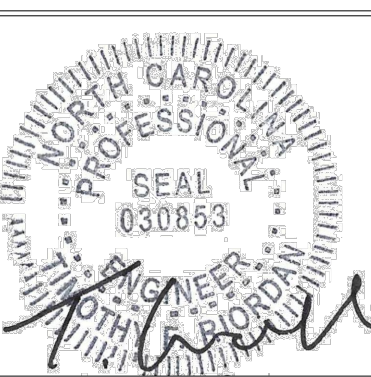
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- AREA REMOVAL
- STRIP SOD
- CLEAR AND GRUB
- SITE ITEM REMOVAL
- ITEM TO BE PROTECTED
- IN-LINE ITEM DEMOLITION
- SAWCUT
- LIMITS OF DISTURBANCE
- CHAIN LINK CONSTRUCTION FENCE



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DEMOLITION PLAN - TRACK

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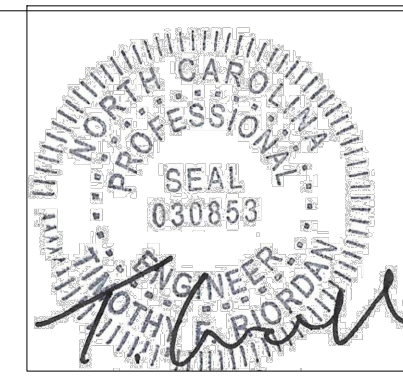
LEGEND

- AREA REMOVAL
- SITE ITEM REMOVAL
- ITEM TO BE PROTECTED
- IN-LINE ITEM DEMOLITION
- SAWCUT
- LOD
- LIMITS OF DISTURBANCE
- CHAIN LINK CONSTRUCTION FENCE



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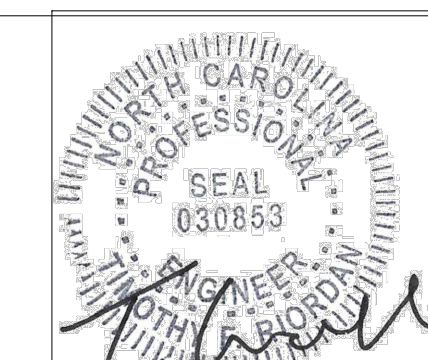
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DEMOLITION PLAN
- THROWS

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OF ANOTHER PERSON AS THEIR OWN. IF ANY PERSON DOES SO, THEY
WILL BE SUBJECT TO THE SEVERE PENALTIES OF THE LAW. THE STATE
OF NORTH CAROLINA DOES NOT GUARANTEE THE ACCURACY OF THE
INFORMATION PROVIDED HEREON. THE USER OF THIS INFORMATION
SHALL BE RESPONSIBLE FOR THE ACCURACY OF THE INFORMATION
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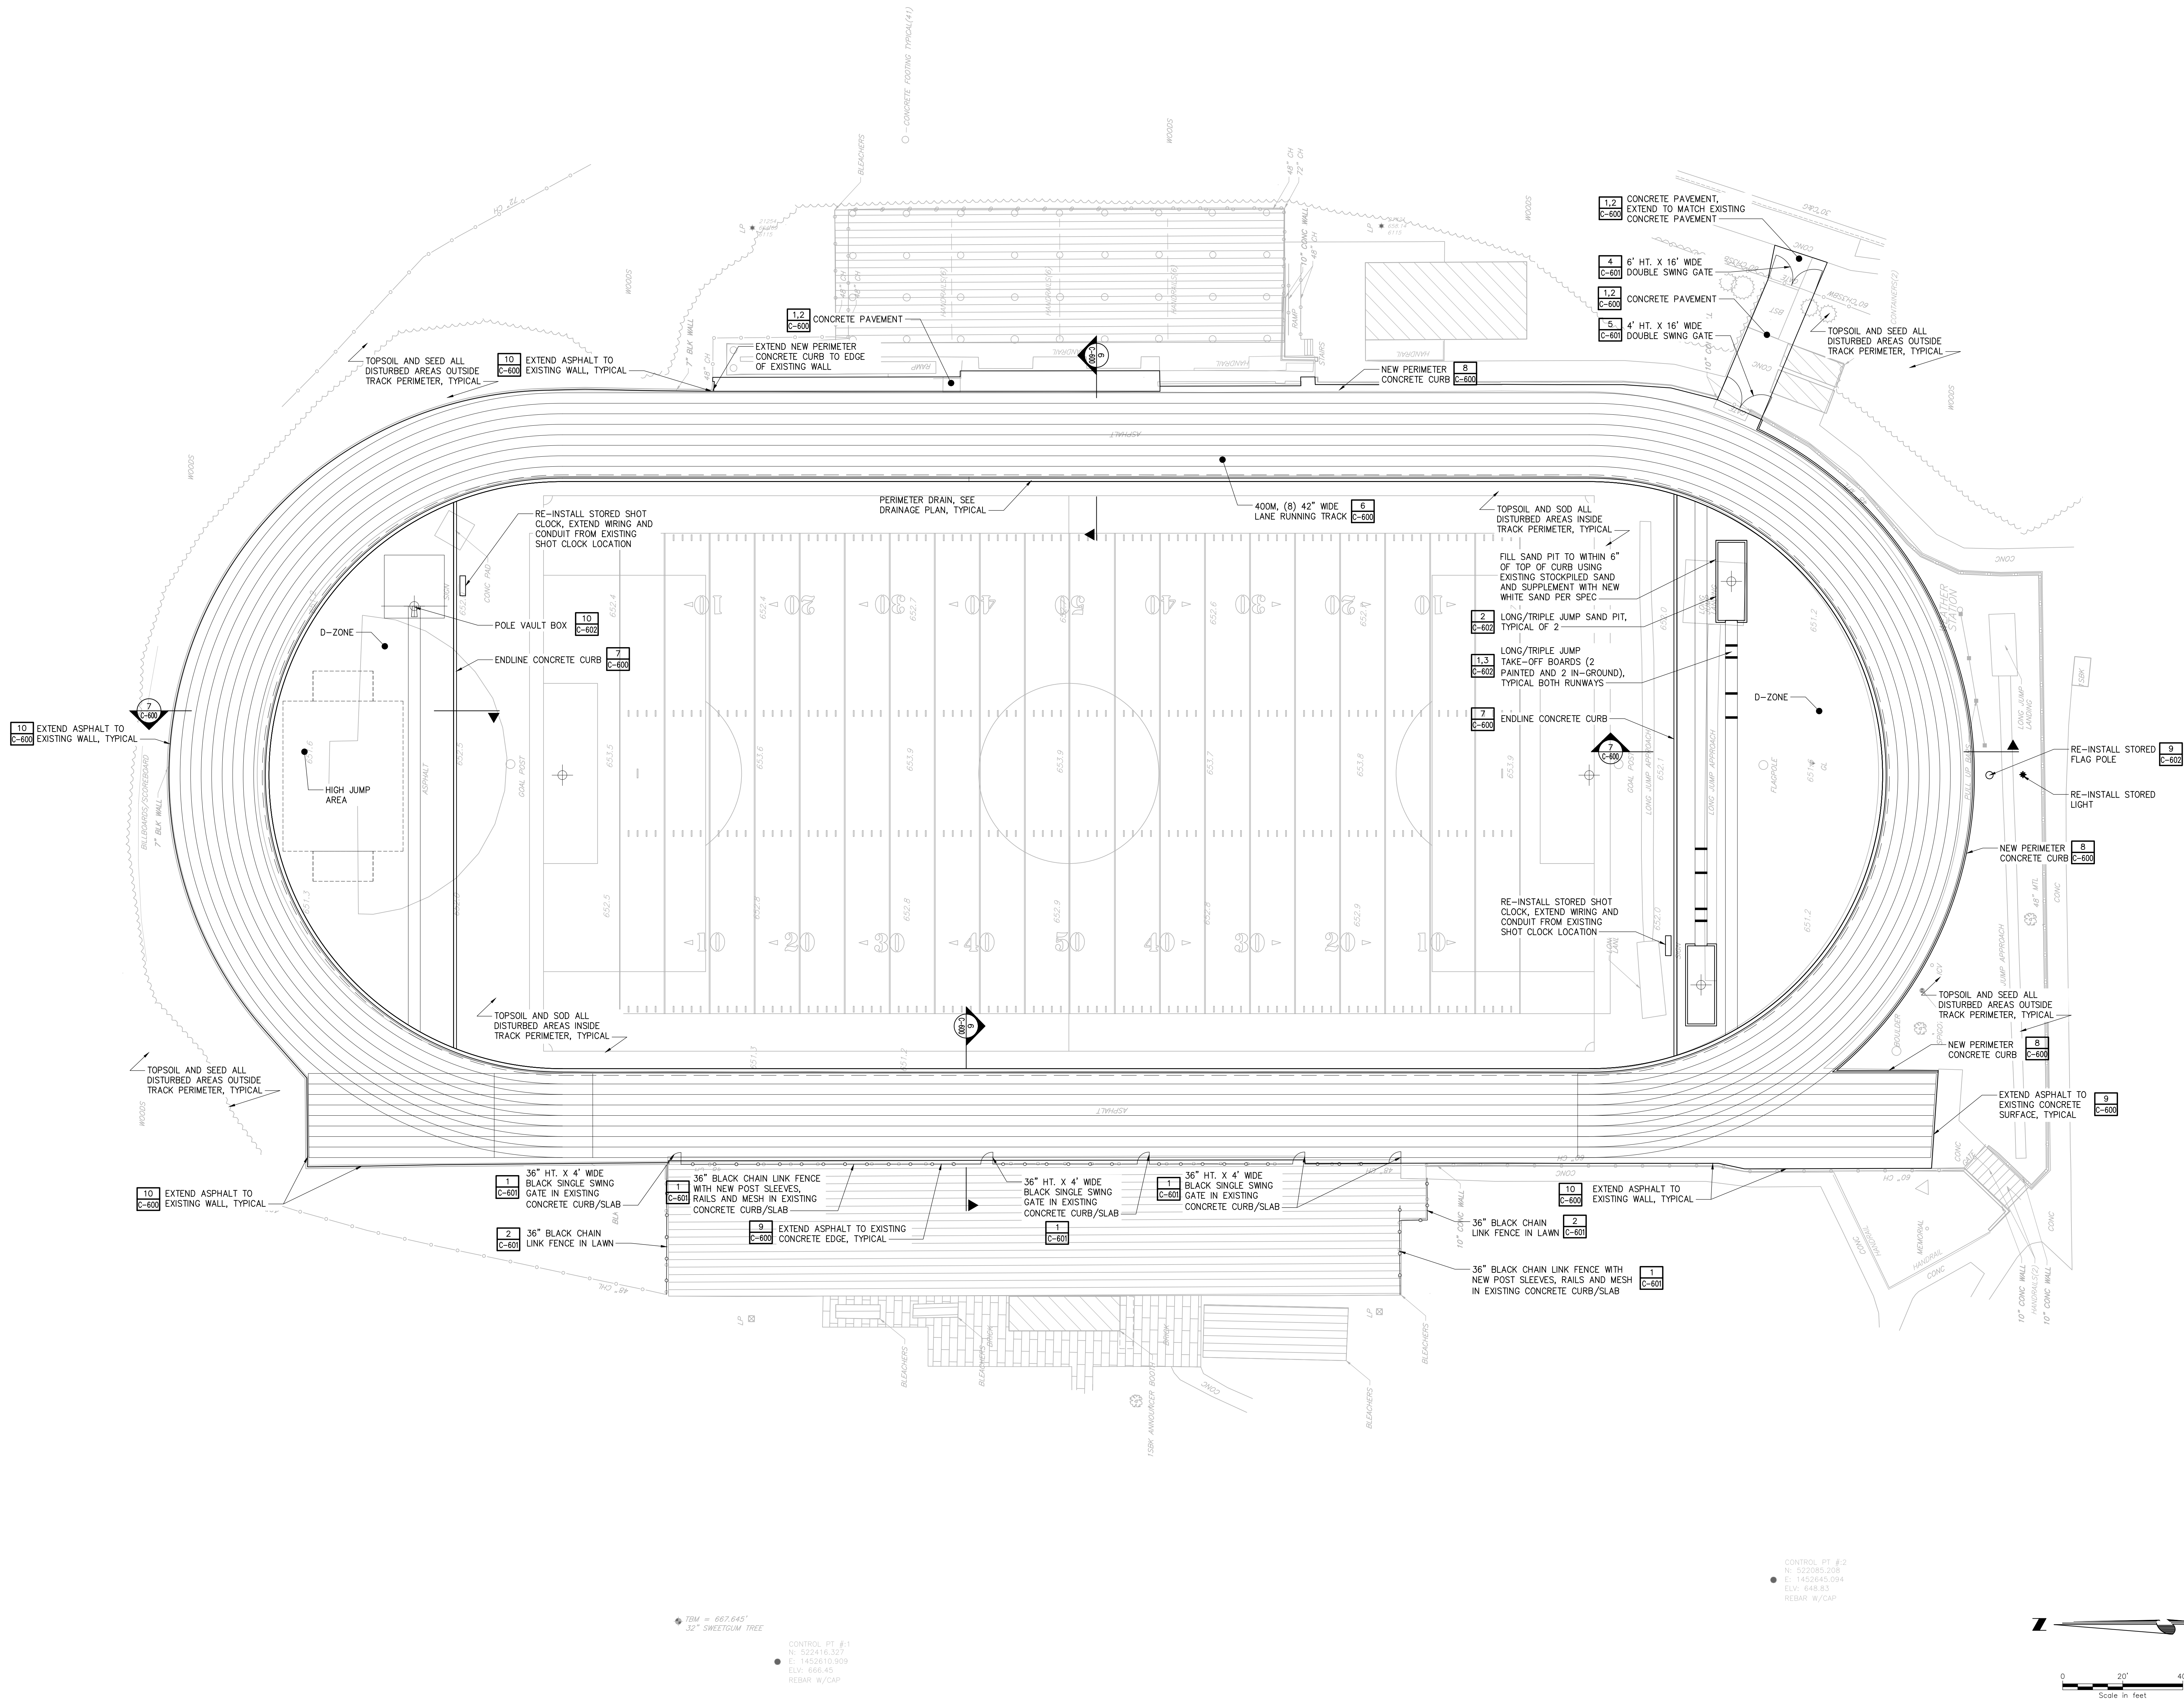
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LAYOUT PLAN -
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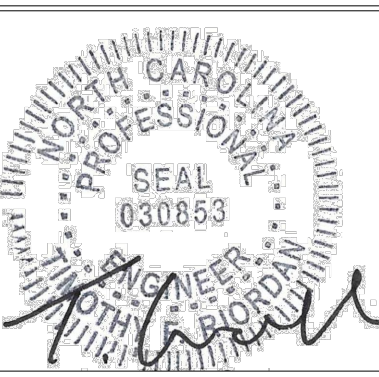
LEGEND

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SURVEYOR TO PREPARE OR SIGN ANY DRAWING. IF THE DRAWING IS
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UNLESS THE PROFESSIONAL IS A LICENSED PROFESSIONAL IN THE STATE
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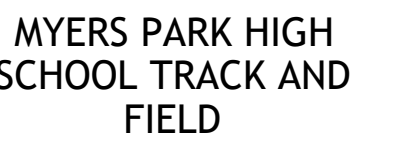
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LAYOUT PLAN -
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
TRACK SURFACING AND DIMENSION PLAN

Drawing No.:
C-110





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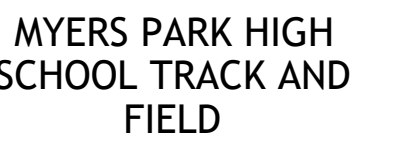
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| GRADING PLAN - TRACK | | | | |

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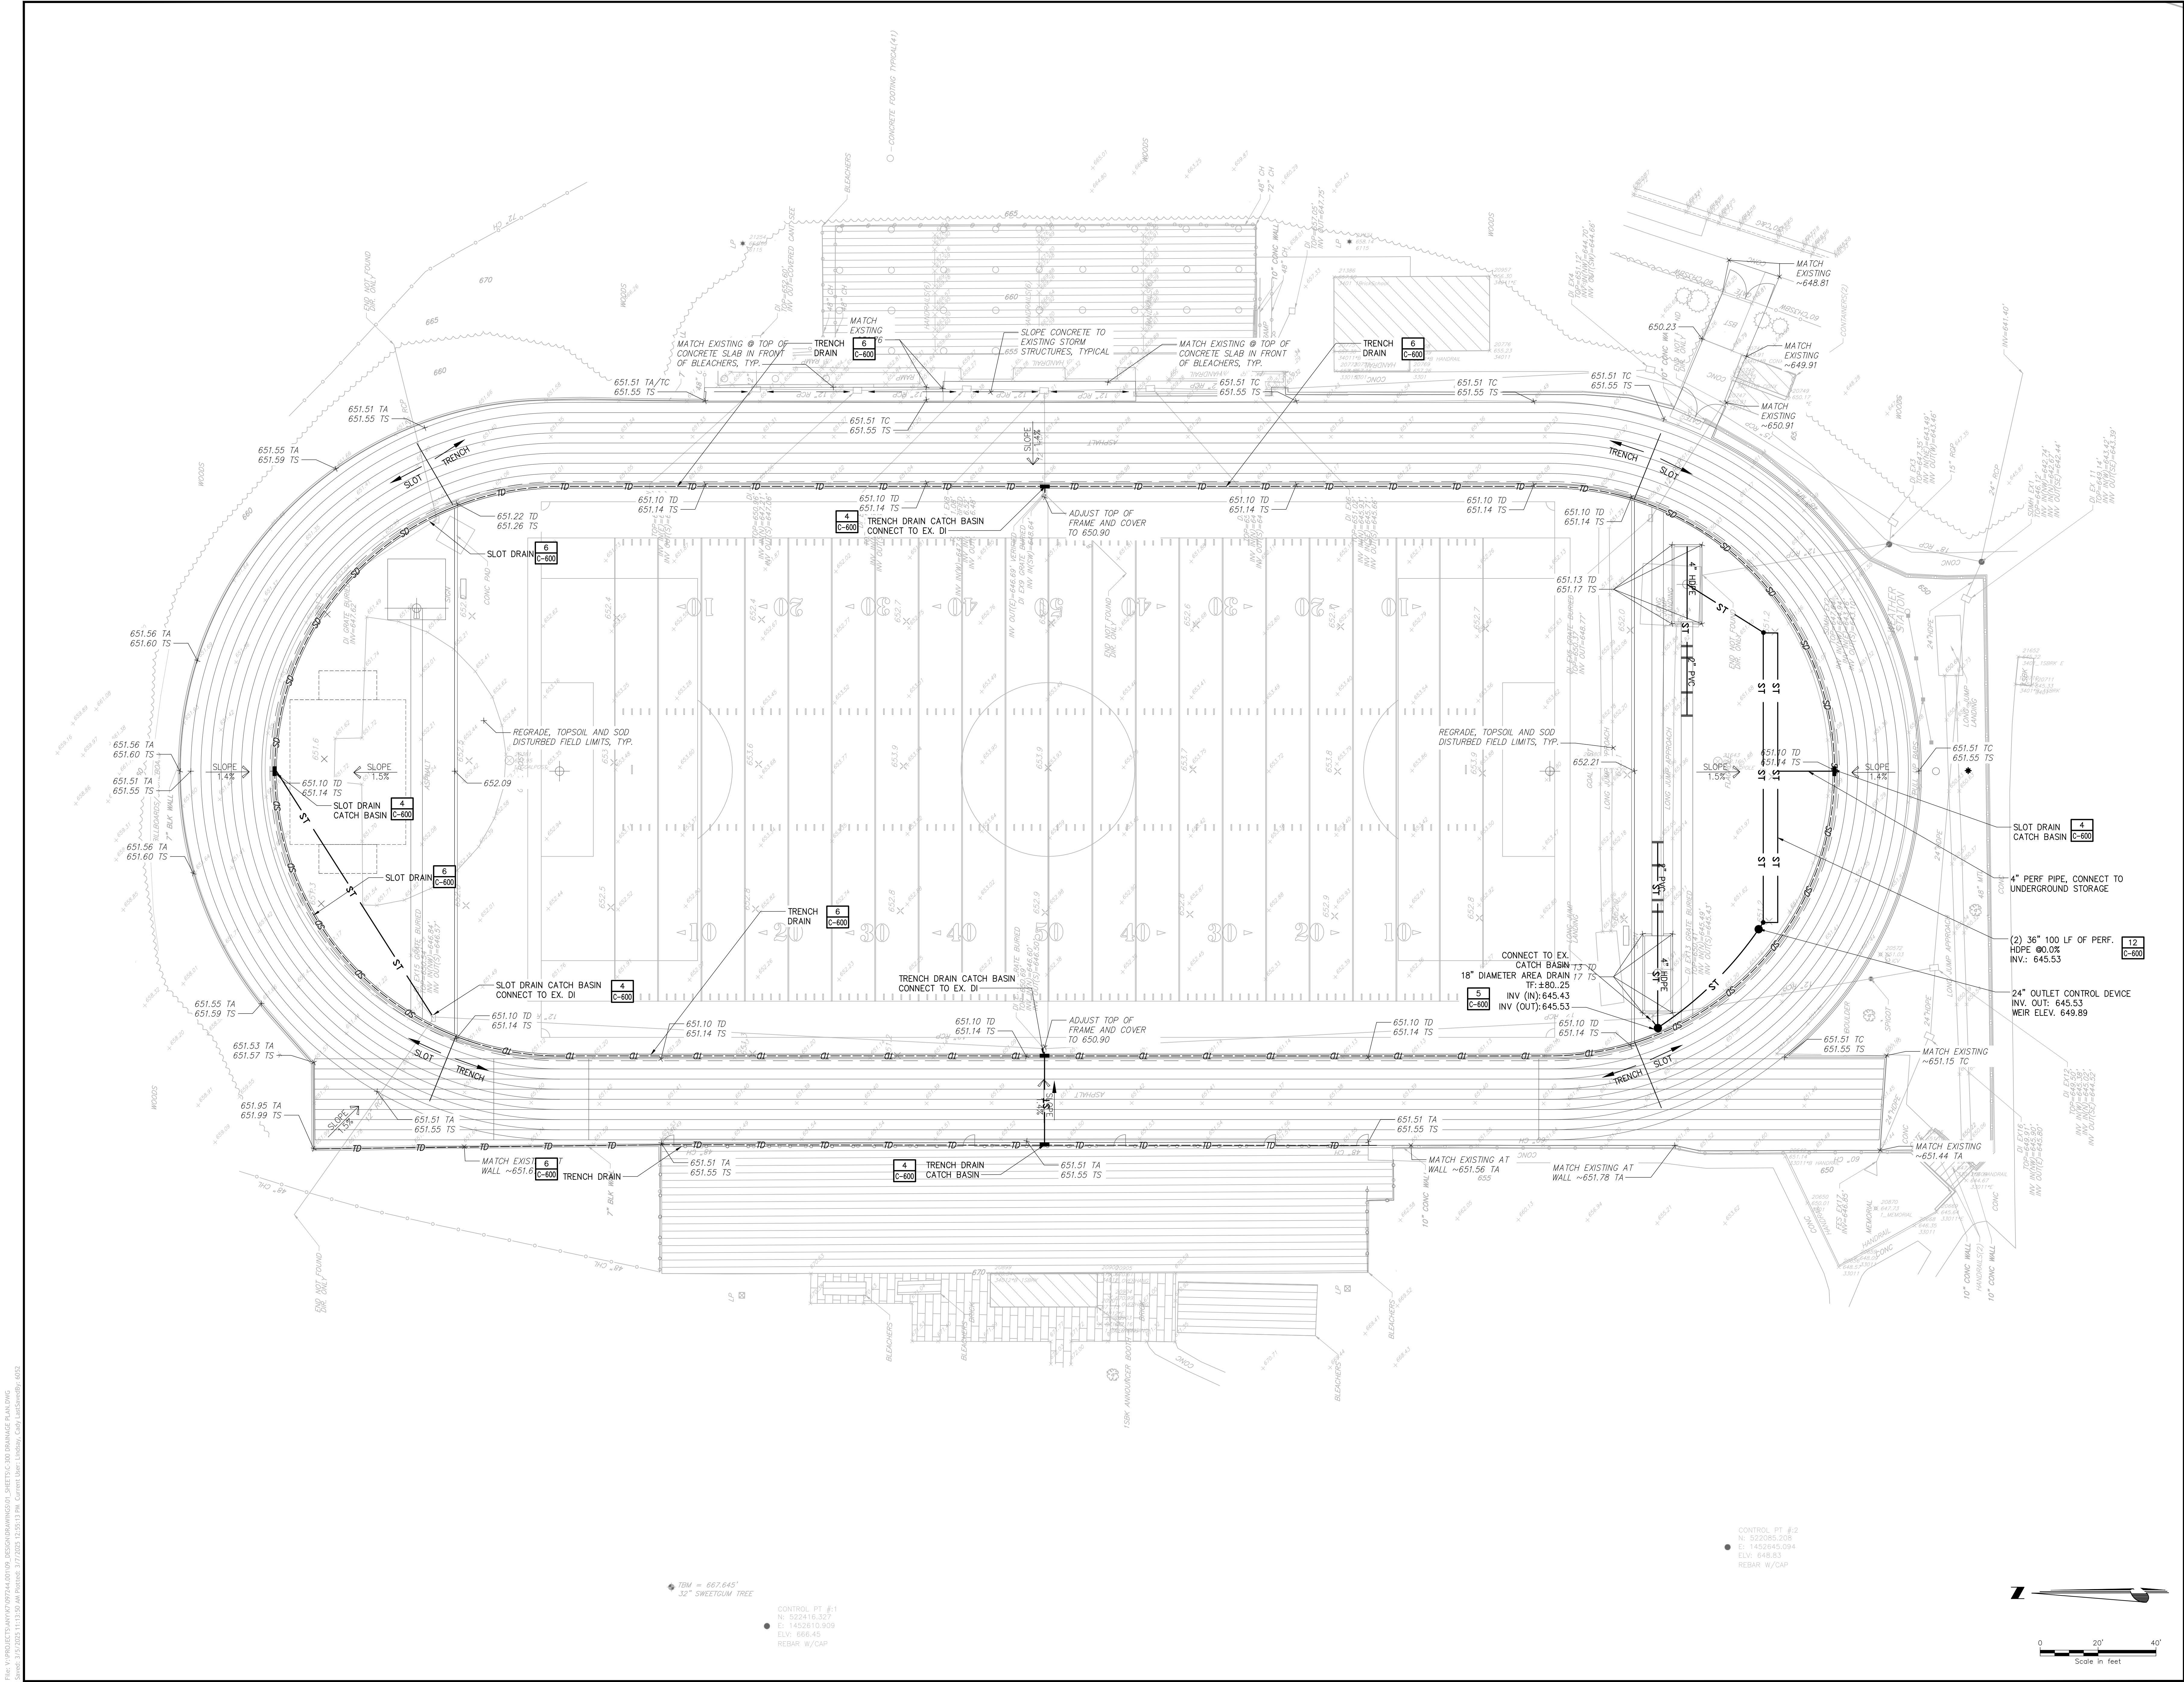
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RAINAGE PLAN - TRACK

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C-300




File: V:\PROJECTS\JAN\707244\00109_DRAINAGE\DRAWINGS\GULI_SHEETS\C-300_DRAINAGE_PLAN.DWG
Sheet: 1 of 2 (2/25/25 11:12:50 AM Project: 7/7/2025 12:52:42 PM Author: J. Lopez Engineer, J. Lopez Surveyor, J. Lopez)



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ACTING UNDER THE DIRECTION OF A LICENSED PROFESSIONAL
ENGINEER, ARCHITECT, LANDSCAPE ARCHITECT OR LAND
SURVEYOR TO PREPARE OR SIGN ANY DRAWING OR SPECIFICATION FOR THE
CONSTRUCTION OF A STRUCTURE OR FOR THE ALTERATION OF THE
LAND OR FOR THE CONSTRUCTION OF A HIGHWAY OR FOR THE
CONSTRUCTION OF A WATERWAY OR FOR THE CONSTRUCTION OF A
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WATERWAY OR FOR THE CONSTRUCTION OF A STRUCTURE OR FOR THE
ALTERATION OF THE LAND.

MYERS PARK HIGH
SCHOOL TRACK AND
FIELD
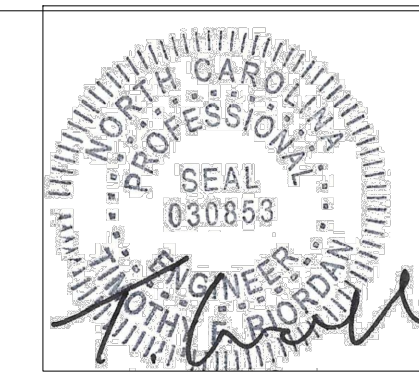
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BID DOCUMENTS CL PG 03/09/25

DRAINAGE PLAN -
THROWS

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| Designed By: TR | Drawn By: CL | Checked By: PG |
| Issue Date: 3/9/25 | Project No.: 97244.001 | Scale: AS SHOWN |

Drawing No.:
C-301

GENERAL NOTES:





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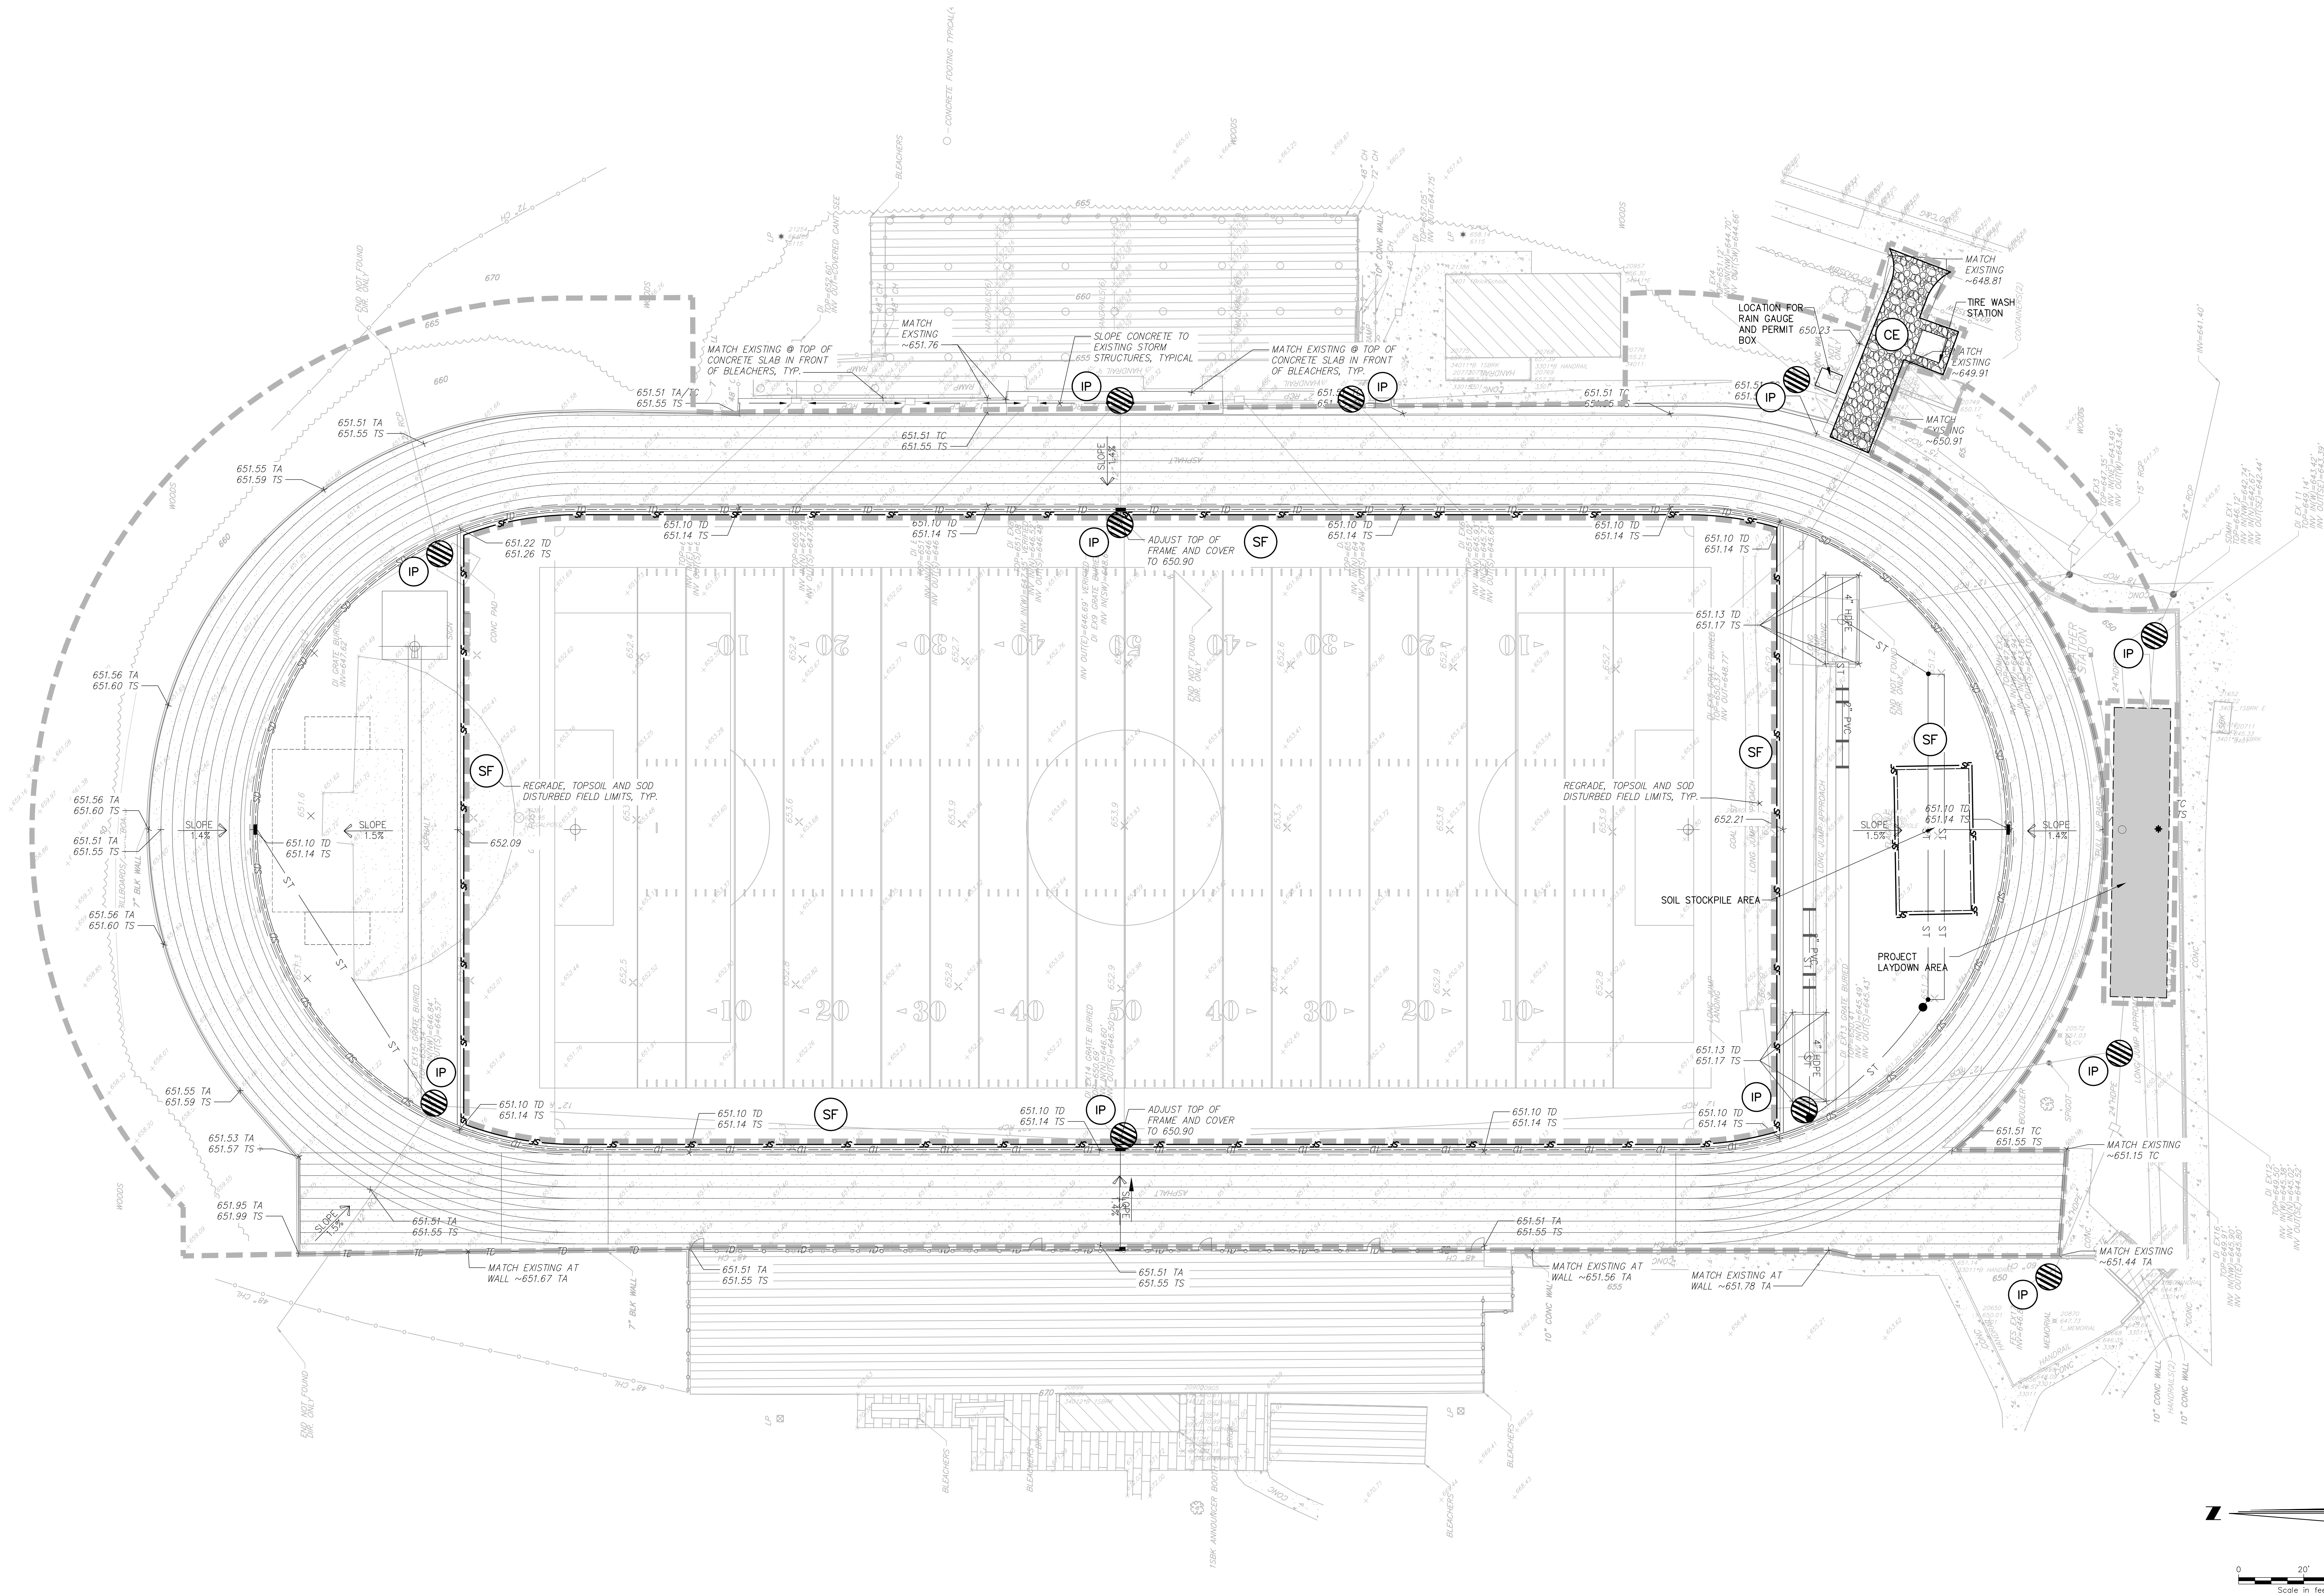
- CONTRACTOR IS TO VERIFY ALL UTILITY LOCATIONS PRIOR TO BEGINNING WORK.
NO WORK SHALL BE IN ACCORDANCE WITH ALL STATE REGULATIONS.
CONTRACTORS ARE TO FULLY ACQUAINT THEMSELVES WITH ALL UTILITIES WITHIN THE CITY AND STATE ROW AND WITHIN THE PROPERTY BOUNDARIES WHICH WILL REQUIRE RELOCATION. ALL COSTS ASSOCIATED WITH RELOCATION SHALL BE INCLUDED IN THE BIDDING.
ALL WORK PERFORMED WITHIN NCOR ROW SHALL BE PER NCOR SPECS AND SHALL BE INSPECTED FOR COMPLIANCE BY STATE INSPECTORS AT THEIR DISCRETION.
ALL OFF-SITE FILL MUST COME FROM AN APPROVED SITE. CONTRACTOR IS RESPONSIBLE FOR PERMITTING BORROW.
NO WORK SHOWN IS BEING PERFORMED IN THE FLOODWAYS LABELED.
STABILIZATION MEASURES SHALL BE INITIATED AS SOON AS PRACTICABLE IN PORTIONS OF THE SITE WHERE CONSTRUCTION ACTIVITIES HAVE BEEN TEMPORARILY CEASED. THERE SHALL BE NO CASE MORE THAN FOURTEEN (14) DAYS AFTER WORK HAS CEASED, EXCEPT AS STATED BELOW.
WHERE STABILIZATION BY THE 14TH DAY IS PRECLUDED BY SNOW COVER OR FROZEN GROUND CONDITIONS STABILIZATION ACTIVITIES MAY BE DEFERRED UNTIL SPRING AS PRACTICABLE.
WHERE CONSTRUCTION ACTIVITY ON A PORTION OF THE SITE IS TEMPORARILY CEASED, AND EARTH-DISTURBING ACTIVITIES ARE NOT COMPLETED WITHIN 14 DAYS, TEMPORARY STABILIZATION MEASURES DO NOT HAVE TO BE INITIATED ON THAT PORTION OF THE SITE.
ALL SEDIMENT AND EROSION CONTROL DEVICES SHALL BE INSPECTED EVERY CALENDAR WEEK IF PERIODIC INSPECTION REVEALS NECESSARY REPLACEMENT OR MODIFICATION REQUIRED TO CORRECT THE BMP WITHIN 48 HOURS OF

9. PROVIDE SILT FENCE AND/OR OTHER CONSTRUCTION DEVICES, AS MAY BE REQUIRED, TO CONTROL SOIL EROSION DURING UTILITY CONSTRUCTION. ALL DISTURBED AREAS SHALL BE CLEANED, GRADED, AND STABILIZED WITH GRASSING IMMEDIATELY AFTER THE UTILITY INSTALLATION, FILL, COVER, AND TEMPORARY SEEDING AT THE END OF EACH DAY ARE RECOMMENDED. IF WATER IS ENCOUNTERED WHILE TRENCHING, THE WATER SHOULD BE FILTERED TO REMOVE SEDIMENT BEFORE BEING PUMPED BACK INTO THE TRENCH.
10. ALL EROSION CONTROL DEVICES SHALL BE PROPERLY MAINTAINED DURING ALL PHASES OF CONSTRUCTION UNTIL THE COMPLETION OF ALL CONSTRUCTION ACTIVITIES AND ALL DISTURBED AREAS HAVE BEEN STABILIZED. ADDITIONAL CONTROL MEASURES MAY BE REQUIRED TO PREVENT EROSION DURING PERIODS OF HEAVY RAIN. WHEN CONSTRUCTION IS COMPLETE, ALL TEMPORARY CONTROL DEVICES SHALL BE REMOVED ONCE CONSTRUCTION IS COMPLETE AND THE SITE IS STABILIZED.
11. THE CONTRACTOR MUST TAKE NECESSARY ACTION TO MINIMIZE THE TRACKING OF MUD ONTO PAVED ROADWAY(S) FROM CONSTRUCTION AREAS AND THE GENERATION OF DUST. THE CONTRACTOR SHALL DAILY REMOVE MUD/SOIL FROM PAVEMENT, DRIVEWAYS, AND CURBS.
12. LITTER, CONSTRUCTION DEBRIS, OILS, FUELS, AND BUILDING PRODUCTS WITH SIGNIFICANT POTENTIAL FOR IMPACT (SUCH AS STOCKPILES OF FRESHLY TREATED LUMBER) AND CONSTRUCTION CHEMICALS THAT COULD BE DISPOSED TO STORM WATER MUST BE PREVENTED FROM BECOMING A POLLUTANT SOURCE IN STORM WATER DISCHARGES.
13. ALL CONSTRUCTION ACTIVITIES ON EXPOSED SOILS SHALL BE CEASED OR GREATLY REDUCED ON LAND-DISTURBING ACTIVITIES HAVE PERMANENTLY OR TEMPORARILY CEASED, AND WILL NOT RESUME FOR A PERIOD OF 7 CALENDAR DAYS.
14. MINIMIZE SOIL COMPACTION AND, UNLESS INFEASIBLE, PRESERVE TOPSOIL.
15. WASH ALL EQUIPMENT AND VEHICLES FROM EQUIPMENT AND VEHICLE WHEELS, WHEEL WASH WATER, AND OTHER WASH WATER. WASH WATER MUST BE TREATED IN A SEDIMENT BASIN OR ALTERNATIVE CONTROL THAT PROVIDES EQUIVALENT OR BETTER TREATMENT PRIOR TO DISCHARGE.

12. MINIMIZE THE DISCHARGE OF POLLUTANTS FROM Dewatering of TRENCHES AND EXCAVATED AREAS. THESE DISCHARGES ARE TO BE PUMPED TO THE APPROPRIATE CLEAN WATER BODY.
13. THE FOLLOWING DISCHARGES FROM SITES ARE PROHIBITED:
 - a. WASTEWATER FROM WASHOUT OF CONCRETE, UNLESS MANAGED BY AN APPROPRIATE CONTROL, SUCH AS A CONCRETE WASHOUT AND CLEANING (CWC) FORM RELEASE, CURE FOGS, CURING COMPOUNDS AND OTHER CONSTRUCTION MATERIALS.
 - b. FUELS, OILS AND OTHER POLLUTANTS USED IN VEHICLE AND EQUIPMENT OPERATION AND MAINTENANCE;
 - c. AND SOAPS OR SOLVENTS USED IN VEHICLE AND EQUIPMENT WASHING.
14. ALL DISCHARGES OF POLLUTANTS TO ANY WATER BODY SHALL BE AT A MINIMUM OF AT LEAST ONCE EVERY CALENDAR WEEK AND MUST BE CONDUCTED UNTIL FINAL STABILIZATION IS REACHED ON ALL AREAS OF THE CONSTRUCTION SITE.
15. TESTING BMPs NEED TO BE MODIFIED OR IF ADDITIONAL BMPs ARE NECESSARY TO COMPLY WITH THE REQUIREMENTS OF THIS PERMIT AND/OR SCS WATER QUALITY STANDARDS, IMPLEMENTATION MUST BE COMPLETED BEFORE THE NEXT STORM EVENT. THE MINIMUM TESTING FREQUENCY SHALL BE DETERMINED BY THE SWPPP AND ALTERNATIVE BMPs MUST BE IMPLEMENTED AS SOON AS REASONABLY POSSIBLE.
16. PROVIDE A SUSTAIN CONVEYANCE FROM DIVERSING INTO BASINS USING A RAP RAP UNDE CHANNEL, SOPE DRAIN, OR TARP.


SYMBOL

| SYMBOL | | DESCRIPTION | STD. & SPEC. |
|---|-----|---------------------------------|--------------|
|  | CE | CONSTRUCTION ENTRANCE | 6.06 |
|  | CRS | CONSTRUCTION ROAD STABILIZATION | 6.80 |
| - - - - - | | | |
|  | SF | SILT FENCE | 6.62 |
|  | IP | INLET PROTECTION | 6.51 |



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MYERS PARK HIGH
SCHOOL TRACK AND
FIELD

| No. | Submittal / Revision | Apv | By | Date |
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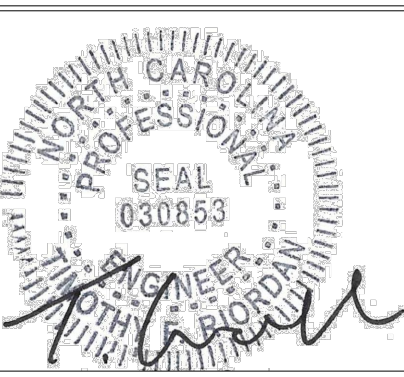
EROSION AND
SEDIMENT
CONTROL PLAN -
TRACK
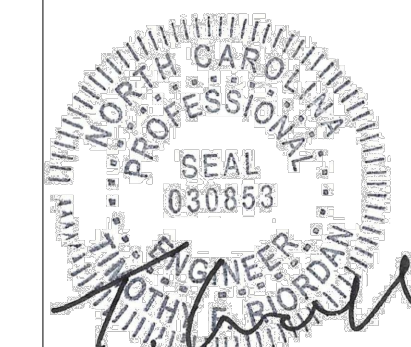
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| Designed By: TR | Drawn By: CL | Checked PG |
| Issue Date: 3/9/25 | Project No.: 97244.001 | Scale: AS SHOWN |

Drawing No.:
C-500

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MYERS PARK HIGH
SCHOOL TRACK AND
FIELD

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| BID DOCUMENTS | CL | PG | 03/09/25 |

EROSION AND SEDIMENT CONTROL PLAN - THROWS

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| Designed By: TR | Drawn By: CL | Checked By: PG |
| Date: 9/25 | Project No.: 97244.001 | Scale: AS SHOWN |

Drawing No.:
C-501



E&SC PERMANENT SEEDING SCHEDULE

COMPLETE SEEDING EARLIER IN THE FALL, AND START LATER IN THE SPRING ON NORTH AND EAST FACING SLOPES.

SOIL AMENDMENTS

APPLY LIME AND FERTILIZER ACCORDING TO SOIL TESTS OR APPLY 4000 LBS/ACER GRASS CULTURAL LIMESTONE AND 1000 LBS/ACRE 5-10-10 FERTILIZER.

MULCH

APPLY 4000-5000 LBS/ACRE GRASS STRAW OR EQUIVALENT COVER OF ANOTHER SUITABLE MULCHING MATERIAL. ANCHOR STRAW BY TACKING WITH ASPHALT, NETTING, OR ROVING. NETTING IS THE PREFERRED ANCHORING METHOD ON STEEP SLOPES.

MAINTENANCE

REFERTILIZE THE SECOND YEAR UNLESS GROWTH IS FULLY ADEQUATE. MOW NO MORE THAN ONCE PER YEAR. RESEED FERTILIZE, AND MULCH DAMAGED AREAS IMMEDIATELY.

SOIL PREPARATION:

SOIL TEST. SOIL TESTING WILL DETERMINE WHETHER THE SOIL PH AND NUTRIENT (PHOSPHORUS, POTASSIUM, CALCIUM AND MAGNESIUM) LEVELS ARE IN A RANGE THAT FAVOR TURFGRASS GROWTH. THE SOIL TEST REPORT WILL INDICATE THE NEEDED AMOUNTS OF FERTILIZER AND/OR LIME.

CLEAN AND ROUGH GRADE: REMOVE ALL DEBRIS FROM THE LOCATION TO BE PLANTED. THIS INCLUDES ROCKS, BOTTLES, LARGE ROOTS AND OLD TREE TRUNKS. IF EXTENSIVE GRADING IS NEEDED, REMOVE THE TOPSOIL AND STOCKPILE IT FOR REPLACEMENT AFTER THE ROUGH GRADE IS ESTABLISHED.

THE SUBSURFACE MAY BECOME COMPACTED DURING ROUGH GRADING, ESPECIALLY IF THE GROUND IS WET. THIS COMPACTED LAYER MUST BE BROKEN UP. A SPRING-TOOTH HARROW WORKS WELL ON LIGHTLY COMPACTED SOILS. A SMALL ROTOTILLER MAY BE NEEDED FOR MORE HEAVILY COMPACTED SITES.

DEEP TILLAGE: ROTOTILLING LOOSENS COMPACTED SOIL AND IMPROVES THE SPEED AND DEPTH OF ROOTING. A TRACTOR-MOUNTED OR SELF-PROPELLED TILLER WILL ADEQUATELY TILL THE SOIL. TAKE CARE NOT TO DESTROY THE EXISTING TREES IN THE LAWN. CUTTING TOO MANY TREE ROOTS DURING SOIL TILLAGE CAN SEVERELY DAMAGE OR KILL A TREE. TREES ARE NOT BEING SURFACED BY DEEP TILLAGE COVERING THE ROOTS WITH SOIL. IF ADDITIONAL SOIL IS NECESSARY AT A TREE BASE, CONSTRUCT A "TREE WELL."

REPLACE THE TOPSOIL: ONCE THE SUBSURFACE IS ESTABLISHED, RETURN THE TOPSOIL AND SPREAD UNIFORMLY OVER THE ENTIRE AREA. ALLOW FOR AT LEAST 6 TO 8 INCHES OF DEPTH AFTER THE SOIL HAS SETTLED. THIS MEANS PLACING 12 TO 16 INCHES OF TOPSOIL ON A 6 TO 8 INCH DEPTH OF SUBSURFACE. IMPROVE THE SOIL BY ADDING ORGANIC MATTER. THIS IMPROVES WATER RETENTION IN SANDY SOILS AND DRAINAGE IN CLAY SOILS AND REDUCES FERTILIZER LEACHING.

E&SC TEMPORARY SEEDING SCHEDULE

MAINTENANCE IF GROWTH IN NOT FULLY ADEQUATE. RESEED, FERTILIZE, AND MULCH IMMEDIATELY FOLLOWING EROSION OR OTHER DAMAGE. TOPDRESS WITH 50 LB/ACRE OF NITROGEN IN MARCH. IF IT IS NECESSARY TO EXTEND TEMPORARILY TO NEW JUNE 15, OVERSEED WITH 50 LB/ACRE KOREAN LESPEDEZA IN LATE FEBRUARY OR EARLY MARCH.

SOIL PREPARATION:

SOIL TEST: SOIL TESTING WILL DETERMINE WHETHER THE SOIL PH AND NUTRIENT (PHOSPHORUS, POTASSIUM, CALCIUM AND MAGNESIUM) LEVELS ARE IN A RANGE THAT FAVOR TURFGRASS GROWTH. THE SOIL TEST REPORT WILL INDICATE NEEDED AMOUNTS OF FERTILIZER AND/OR LIMES.

CLEAN AND ROUGH GRADE: REMOVE ALL DEBRIS FROM THE LOCATION TO BE PLANTED. THIS INCLUDES ROCKS, BOTTLES, LARGE ROOTS AND OLD TREE TRUNKS. IF EXTENSIVE GRADING IS NEEDED, REMOVE THE TOPSOIL AND STOCKPILE IT FOR REPLACEMENT AFTER THE ROUGH GRADE IS ESTABLISHED.

THE SUBSURFACE MAY BECOME COMPACTED DURING ROUGH GRADING ESPECIALLY IF THE GROUND IS WET. THIS COMPACTED LAYER MUST BE BROKEN UP. A SPRING-TOOTH HARROW WORKS WELL ON LIGHTLY COMPACTED SOILS; A SMALL ROTOTILLER MAY BE NEEDED FOR MORE HEAVILY COMPACTED SITES.

DEEP TILLAGE: ROTOTILLING LOOSENS COMPACTED SOIL AND IMPROVES THE SOIL DEPTH AND ROOTING. A TRACTOR-MOUNTED OR SELF-PROPELLED TILLER WILL ADEQUATELY TILL THE SOIL. TAKE CARE NOT TO DESTROY THE EXISTING TREES IN THE LAWN. CUTTING TOO MANY TREE ROOTS DESTROYS THEM. TILLAGE CAN SEVERELY DAMAGE OR KILL A TREE. TREES CAN ALSO BE SUFFOCATED BY DEEPLY COVERING THE ROOTS WITH SOIL. IF ADDITIONAL SOIL IS NECESSARY AT A TREE BASE, CONSTRUCT A "TREE WELL."

REPLACE THE TOPSOIL: ONCE THE SUBSURFACE IS ESTABLISHED, RETURN THE TOPSOIL AND SPREAD UNIFORMLY OVER THE ENTIRE AREA. ALLOW FOR AT LEAST 6 TO 8 INCHES OF DEPTH AFTER THE SOIL HAS SETTLED. THIS MEANS PLACING ABOUT 1 1/2 INCHES OF TOPSOIL ON THE SUBSURFACE. IMPROVE THE SOIL BY ADDING ORGANIC MATTER. THIS IMPROVES WATER RETENTION IN SANDY SOILS AND DRAINAGE IN CLAY SOILS AND REDUCES FERTILIZER LEACHING.

1. Create designated hazardous waste collection areas on-site.
2. Place hazardous waste containers under cover or in secondary containment.
3. Do not store hazardous chemicals, drums or bagged materials directly on the ground.

EFFECTIVE: 04/01/19

- (a) The E&S plan authority has been provided with documentation of the non-surface withdrawal and the specific time periods or conditions in which it will occur. The non-surface withdrawal shall not commence until the E&S plan authority has approved these items.
- (b) The non-surface withdrawal has been reported as an anticipated bypass in accordance with Part III, Section C, Item (2)(c) and (d) of this permit.
- (c) Dewatering discharges are treated with controls to minimize discharges of pollutants from stormwater that is removed from the sediment basin. Examples of appropriate controls include properly sited, designed and maintained dewatering tanks, weir tanks, and filtration systems.
- (d) Vegetated, upland areas of the sites or a properly designed tone pad is used to the extent feasible at the outlet of the dewatering treatment devices described in Item (c) above.
- (e) Velocity dissipation devices such as check dams, sediment traps, and riprap are installed at the discharge points of all dewatering devices, and
- (f) Sediment removed from the dewatering treatment devices described in Item (c) above is disposed of in a manner that does not cause deposition of sediment into waters of the United States.

DRAW DOWN OF SEDIMENT BASINS FOR MAINTENANCE OR CLOSE OUT

| Occurrence | Reporting Timeframes (After Discovery) and Other Requirements |
|---|--|
| <p>(a) Visible sediment deposition in a stream or wetland</p> | <p>• Within 24 hours, an oral or electronic notification.</p> <p>• Within 7 calendar days, a report that contains a description of the sediment and activities to address the cause of the deposition. Division staff may waive the requirement for a written report on a case-by-case basis.</p> <p>• If the stream is named on the NC 303(a) list as impaired for sediment-related causes, the permittee may be required to perform additional monitoring, inspections or apply more stringent practices if staff determine that additional sediment control measures are needed to assure compliance with the federal or state water quality standards.</p> |
| <p>(b) Oil spills and releases of hazardous substances per Item 105(c) above</p> | <p>• Within 24 hours, an oral or electronic notification. The notification shall include information about the date, time, nature, volume and location of the spill or release.</p> |
| <p>(c) Anticipated bypasses (40 CFR 122.41(a)(5))</p> | <p>• A report at least ten days before the date of the bypass, if possible. The report shall include an evaluation of the anticipated quality and effect of the bypass.</p> |
| <p>(d) Unanticipated bypasses (40 CFR 122.41(a)(5)(i))</p> | <p>• Within 24 hours, an oral or electronic notification.</p> <p>• Within 7 calendar days, a report that includes an evaluation of the quality and effect of the bypass.</p> |
| <p>(e) Noncompliance with the conditions of this permit that may endanger wildlife or fish or aquatic environment (40 CFR 122.41(a)(7))</p> | <p>• Within 24 hours, an oral or electronic notification.</p> <p>• Within 7 calendar days, a report that contains a description of the noncompliance, and its causes; the period of noncompliance, including exact dates and times; and if the noncompliance has not been corrected, the anticipated duration of the noncompliance to continue; and steps taken or planned to reduce, eliminate, and prevent recurrence of the noncompliance. (40 CFR 122.41(a)(6)).</p> <p>• Division staff may waive the requirement for a written report on a case-by-case basis.</p> |

EFFECTIVE: 04/01/19

EROSION AND
SEDIMENT
CONTROL NOTES

| No. | Submitted / Revision | Appr | By | Date |
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BID DOCUMENTS CL PG 03/09/25

SITE DETAILS


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| Designed By: TR | Drawn By: CL | Checked By: PG |
| Issue Date: 3/9/25 | Project No.: 97244.001 | Scale: AS SHOWN |

Drawing No.:

C-600

1 CONCRETE PAVEMENT


SCALE:

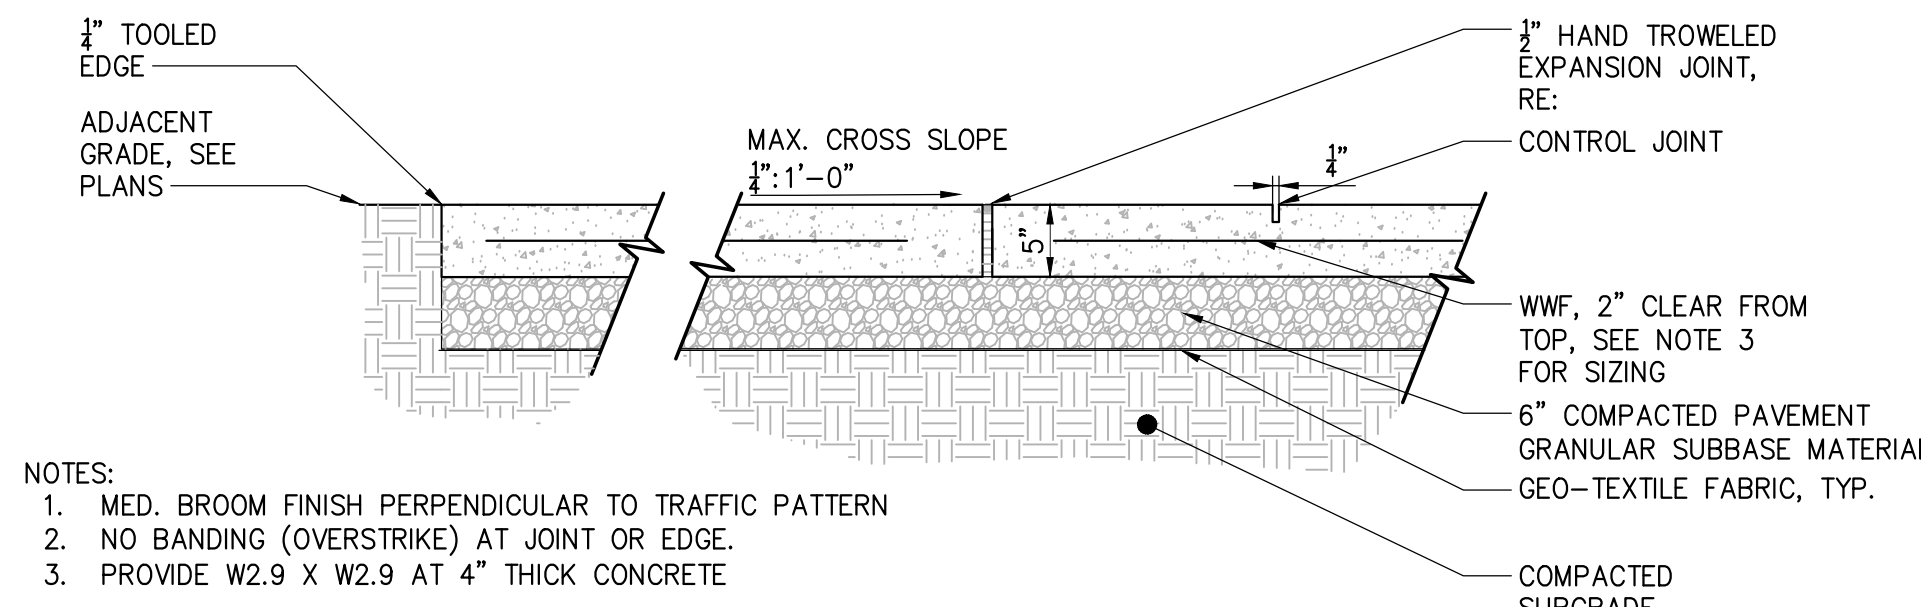

- NOTES:
1. MED. BROOM FINISH PERPENDICULAR TO TRAFFIC PATTERN
 2. NO BANDING (OVERSTRIKE) AT JOINT OR EDGE.
 3. PROVIDE W2.9 X W2.9 AT 4" THICK CONCRETE


2 CONCRETE PAVEMENT JOINTS

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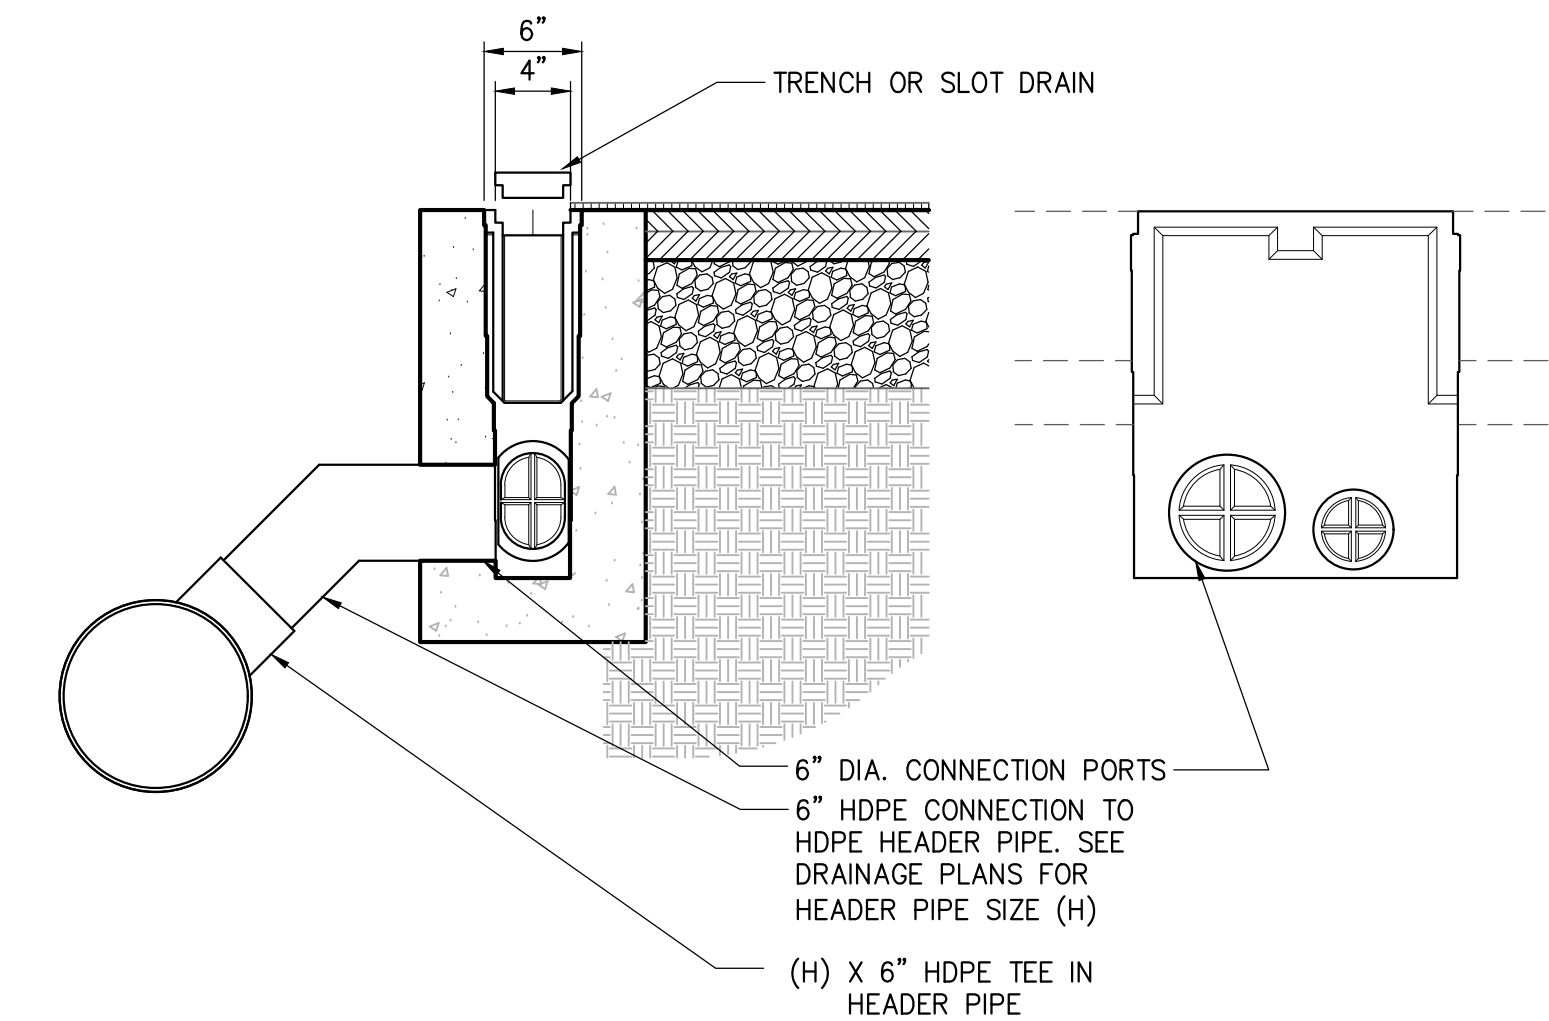
3 TYPICAL STORM TRENCH DETAIL

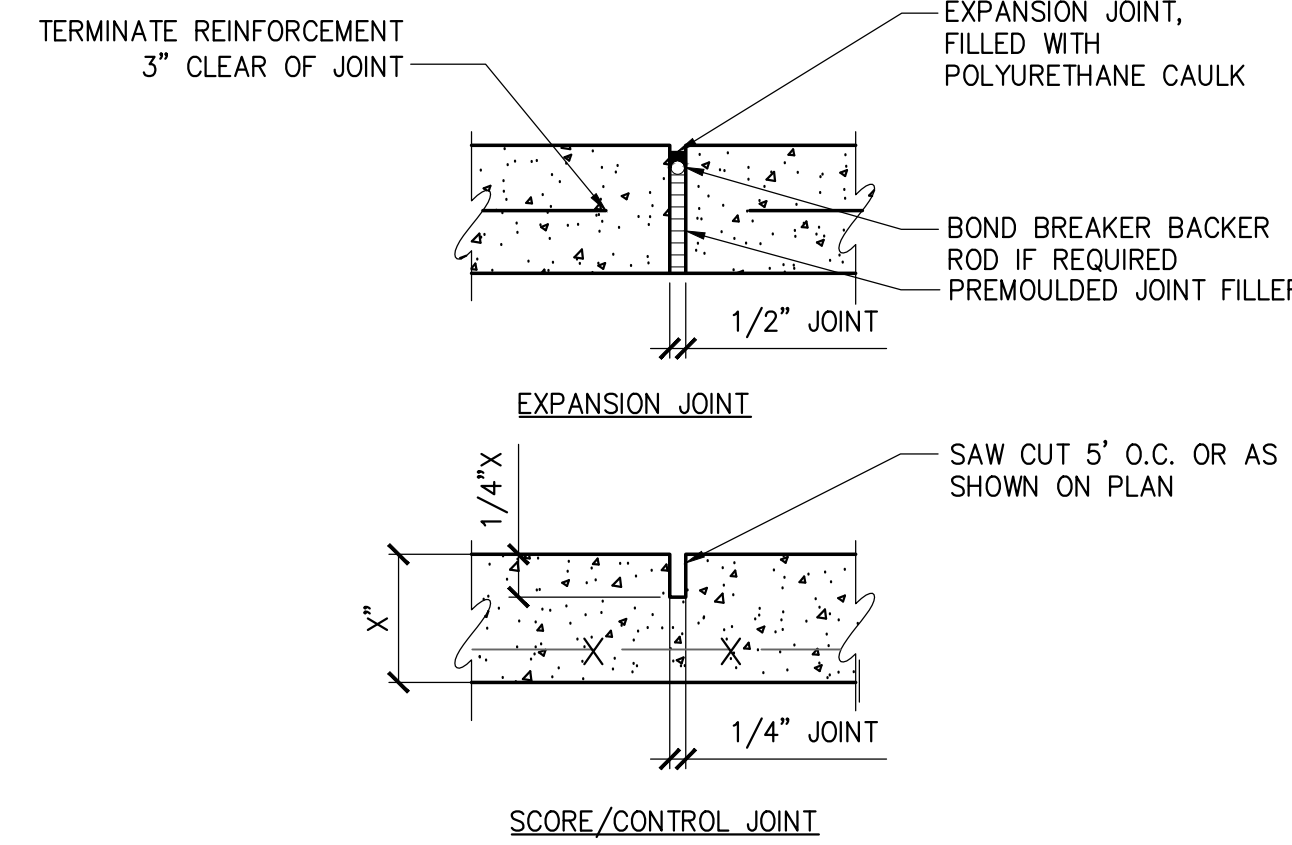SCALE:




4 TRENCH DRAIN CATCH BASIN DETAILS

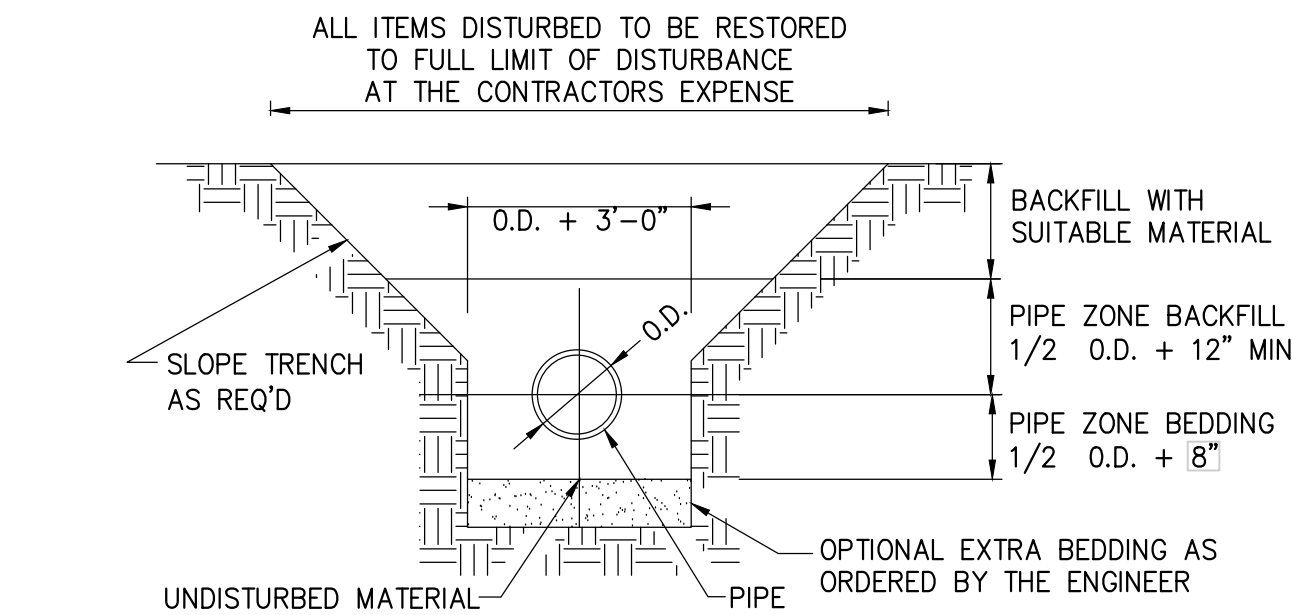SCALE: NTS




5 AREA DRAIN/CLEANOUT DETAIL

SCALE: NTS

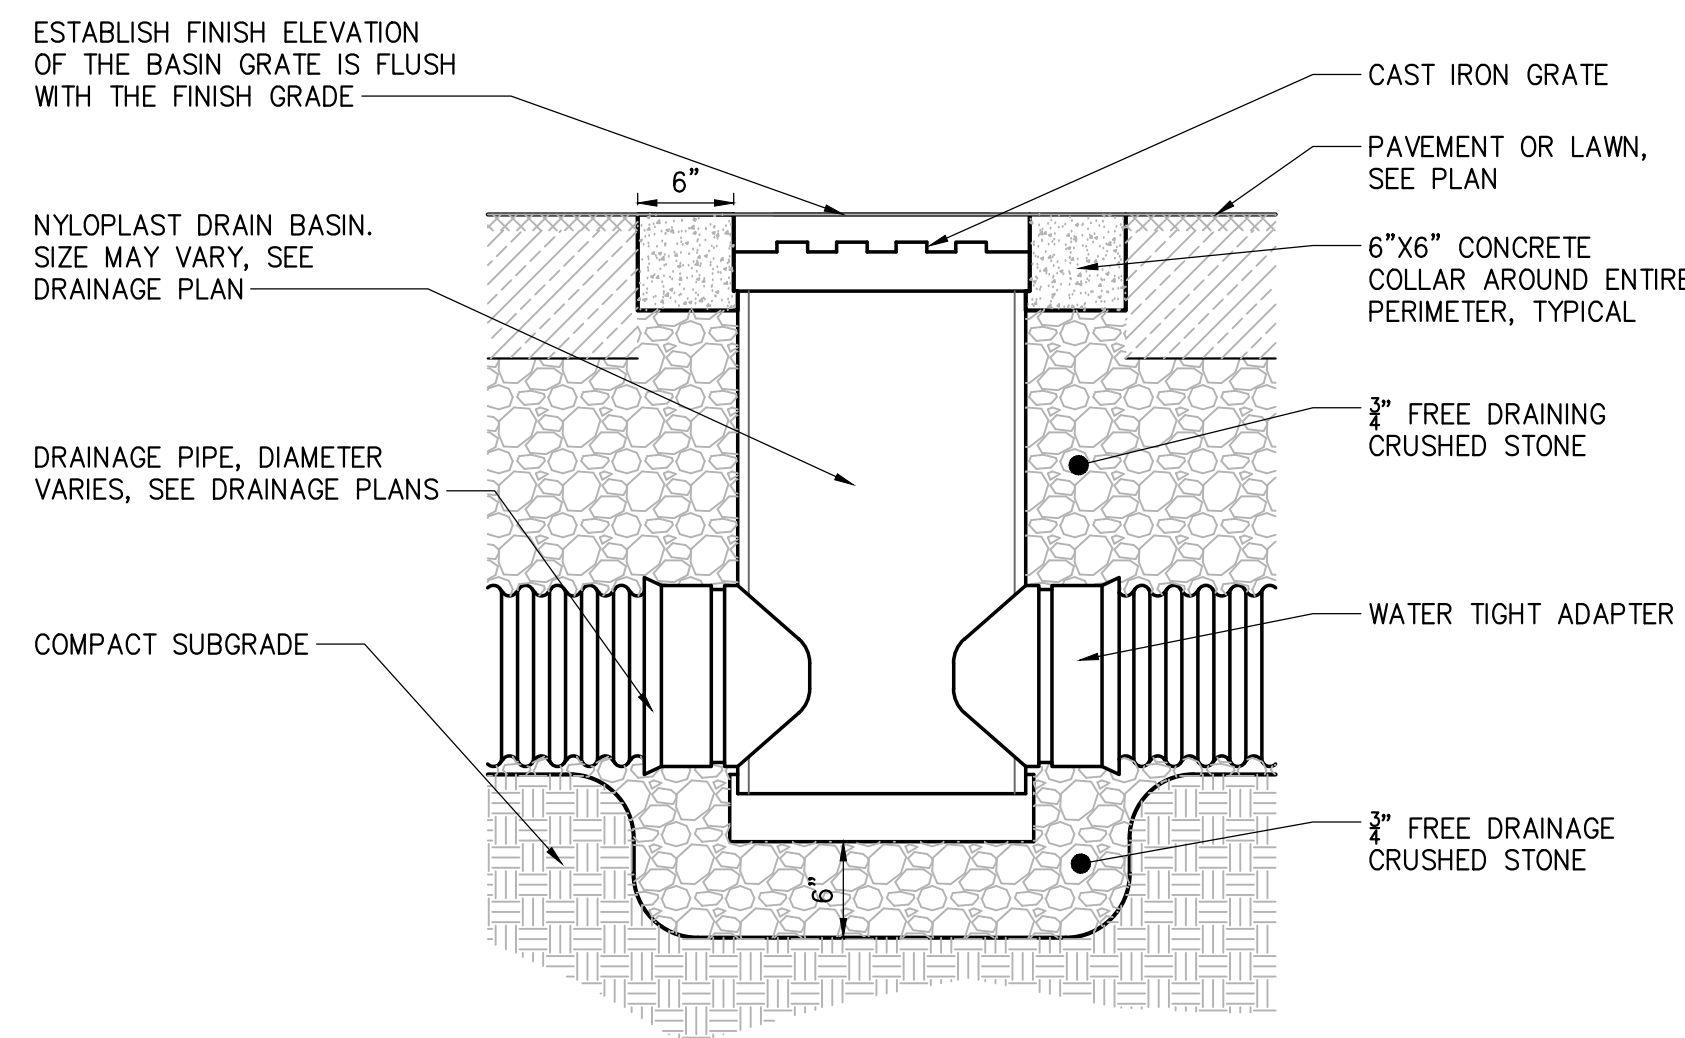


6 TRACK CROSS SECTION AT TRENCH DRAIN

SCALE: NTS

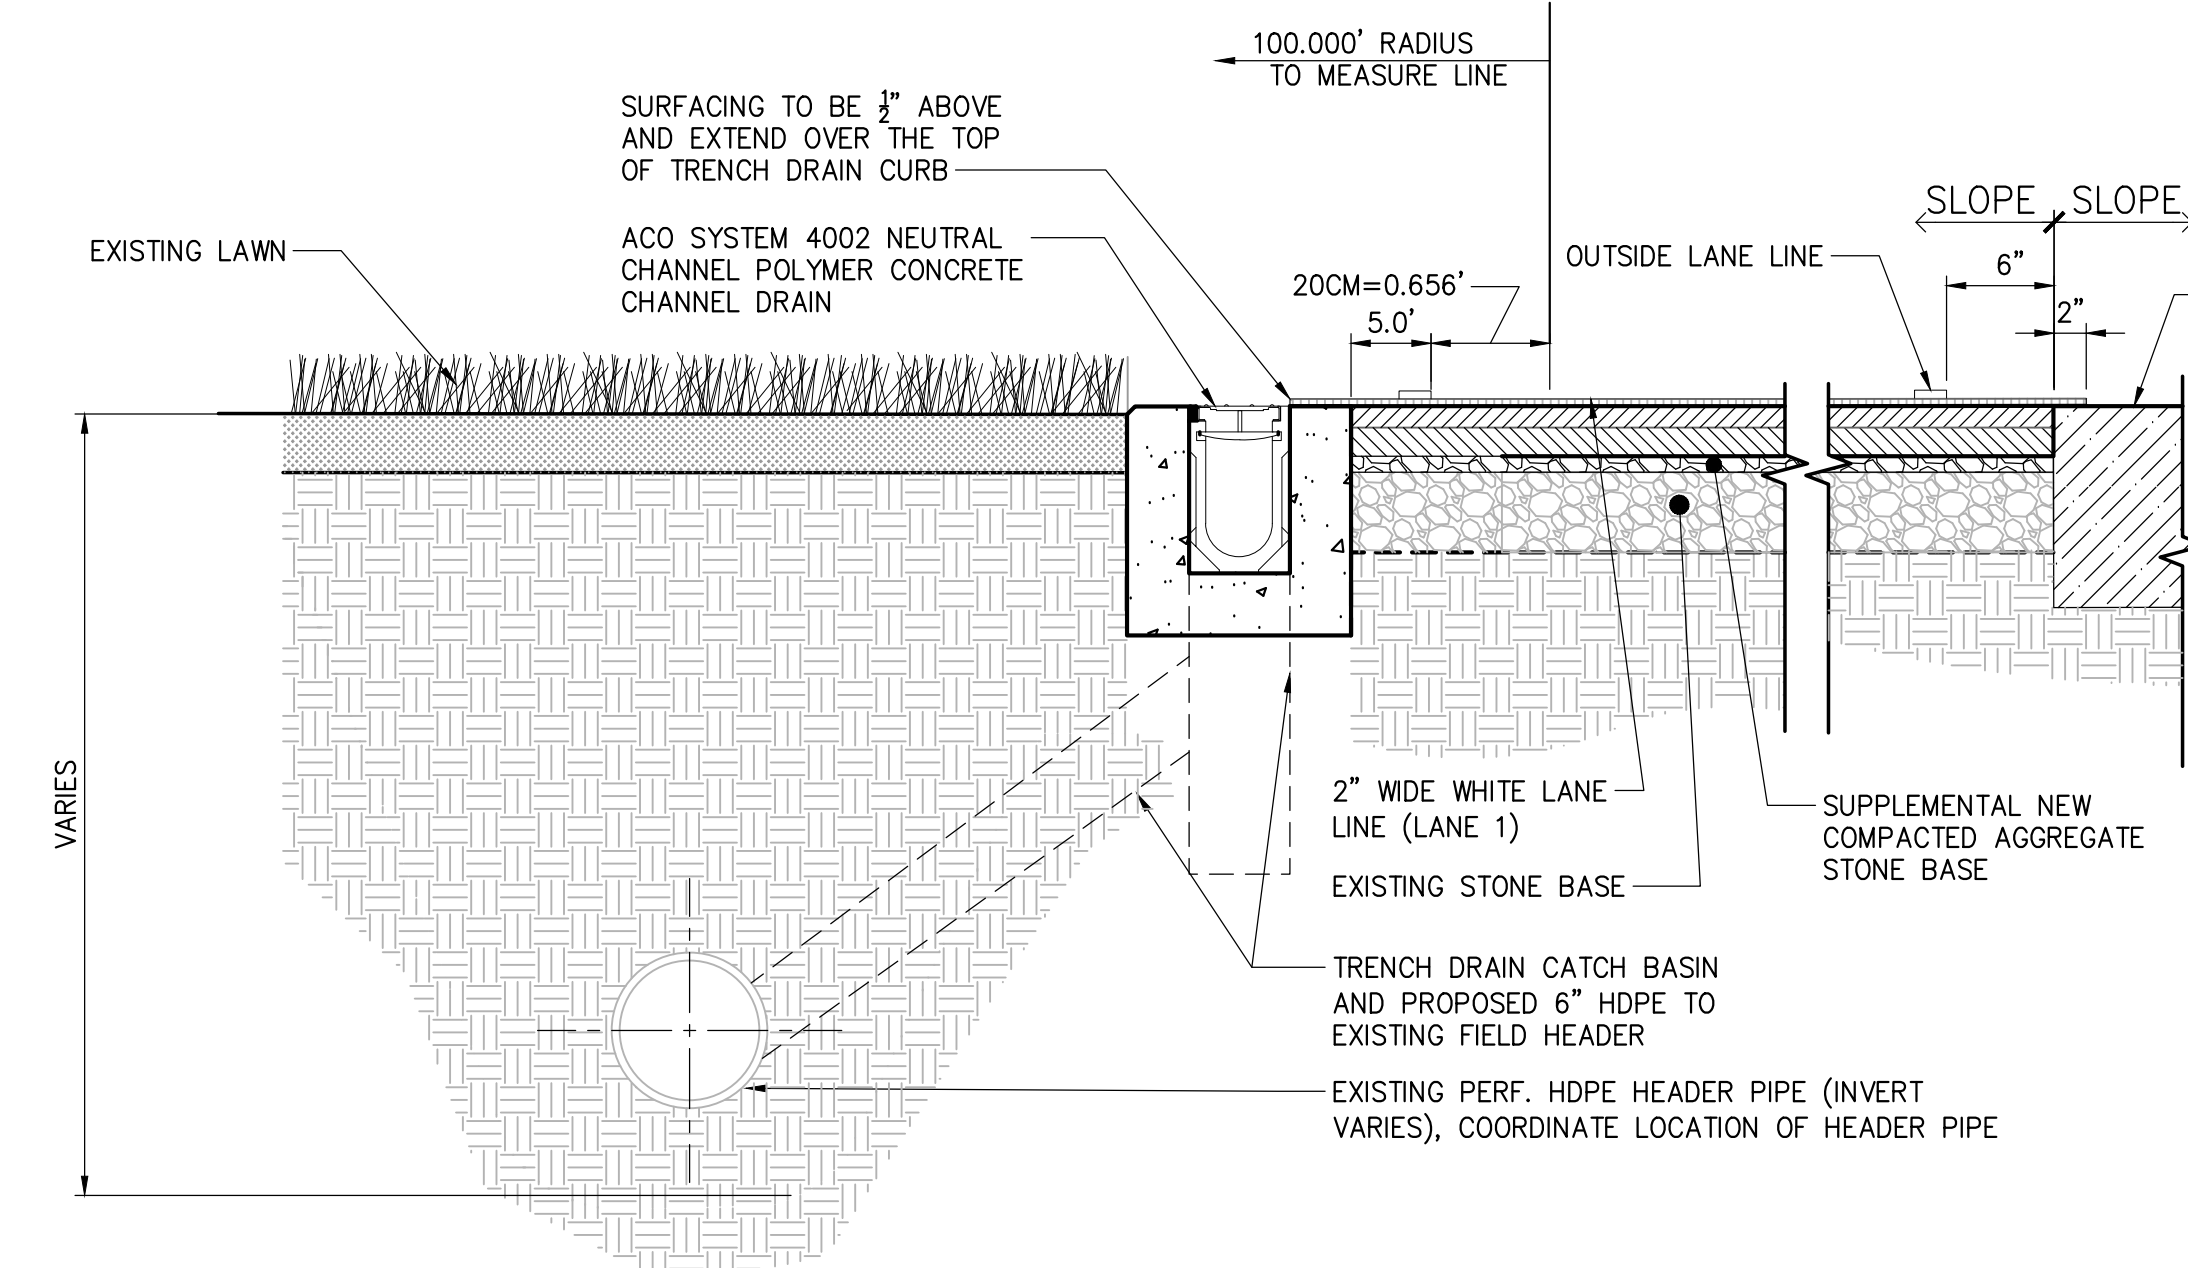


7 TRACK CROSS SECTION AT D-ZONES

SCALE: NTS

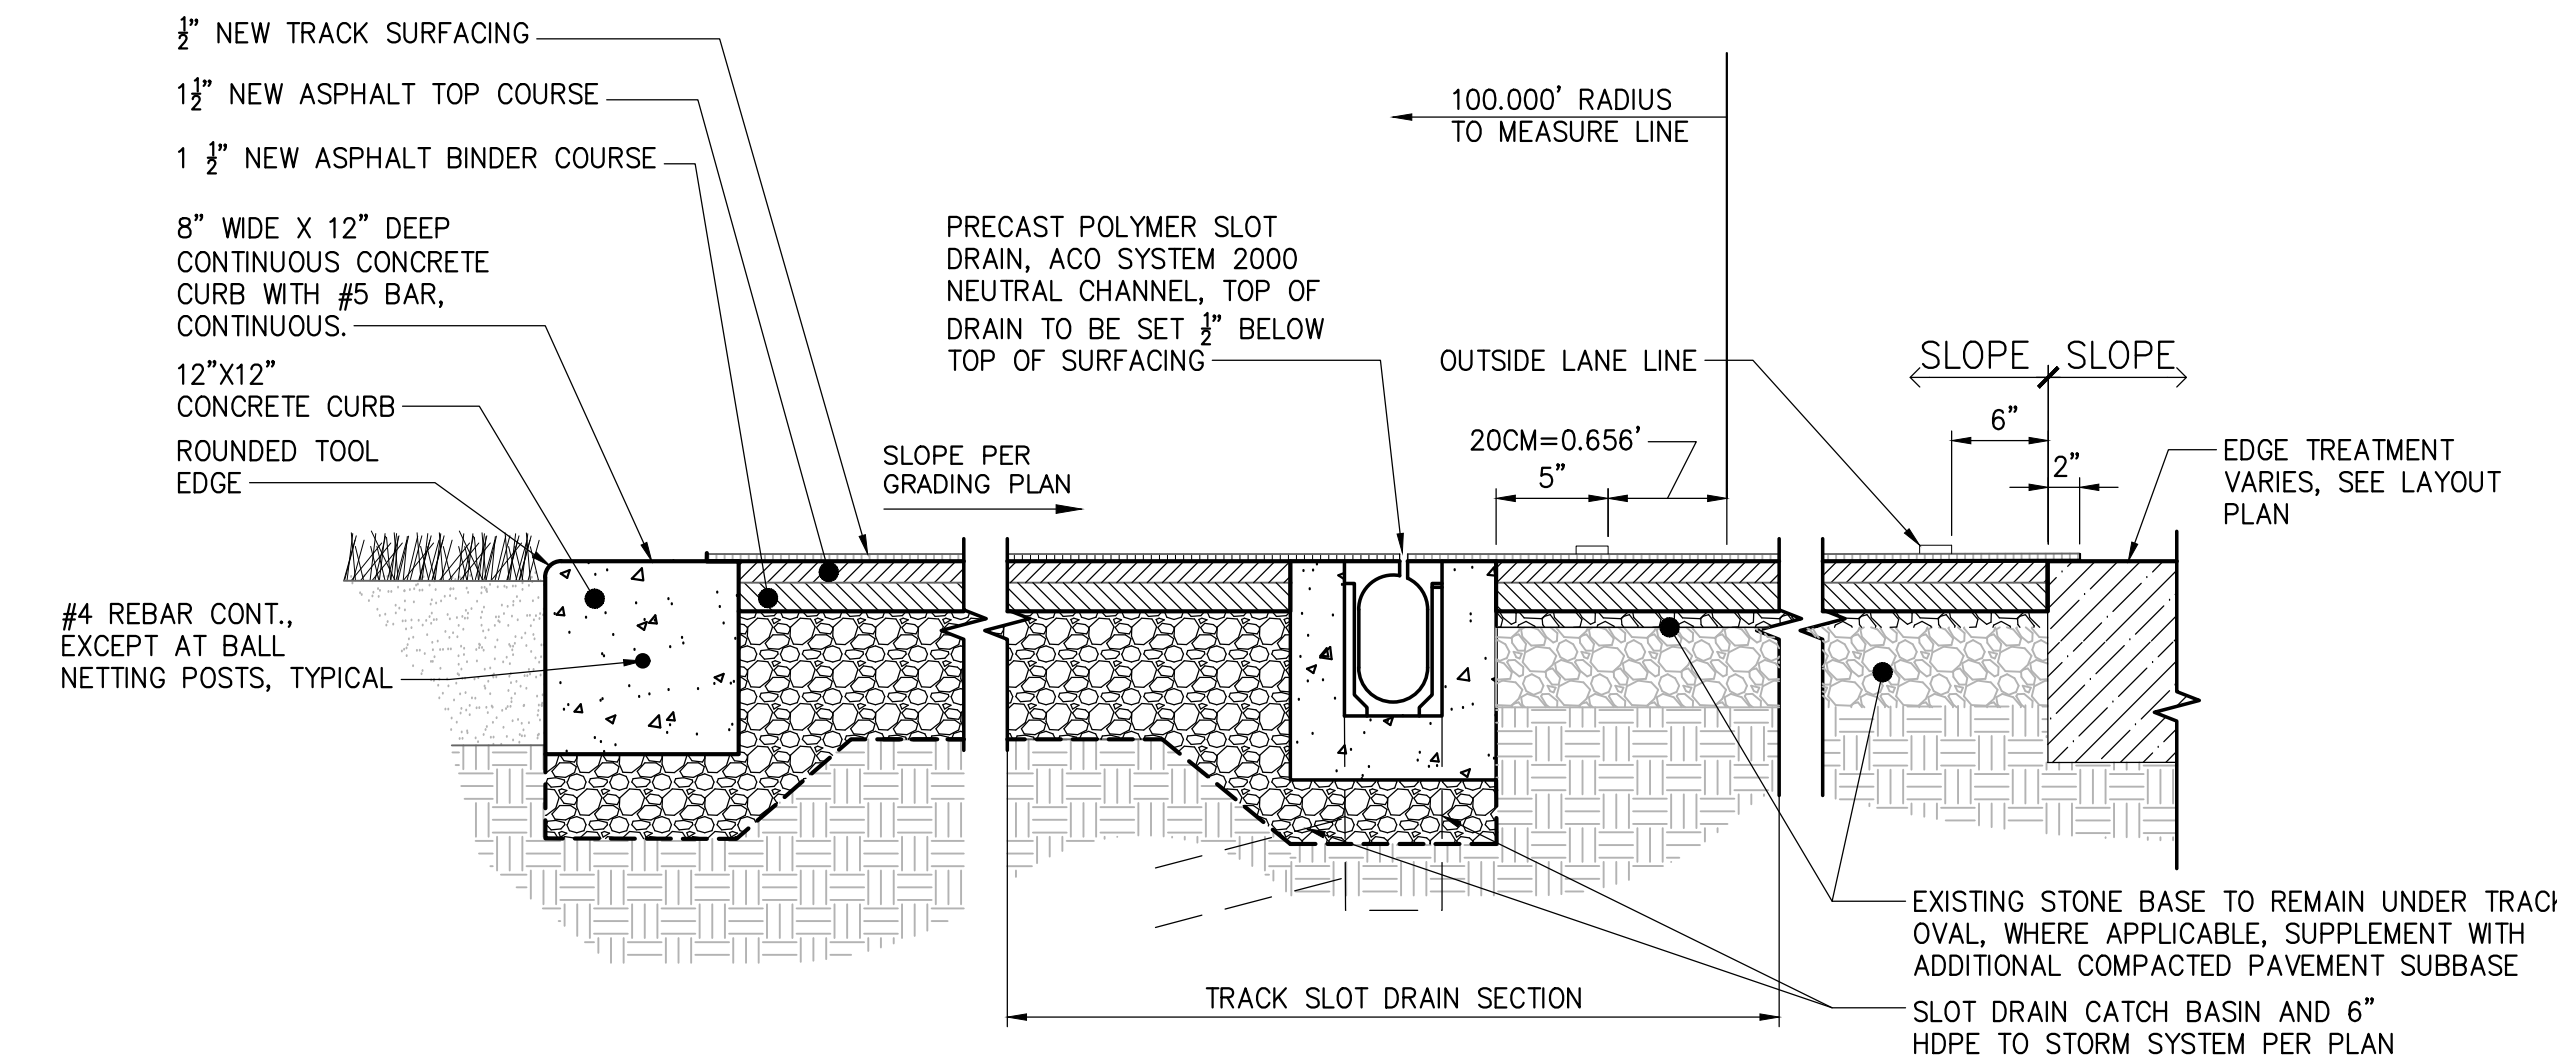


8 TRACK PERIMETER AT NEW CONCRETE CURB

SCALE: NTS

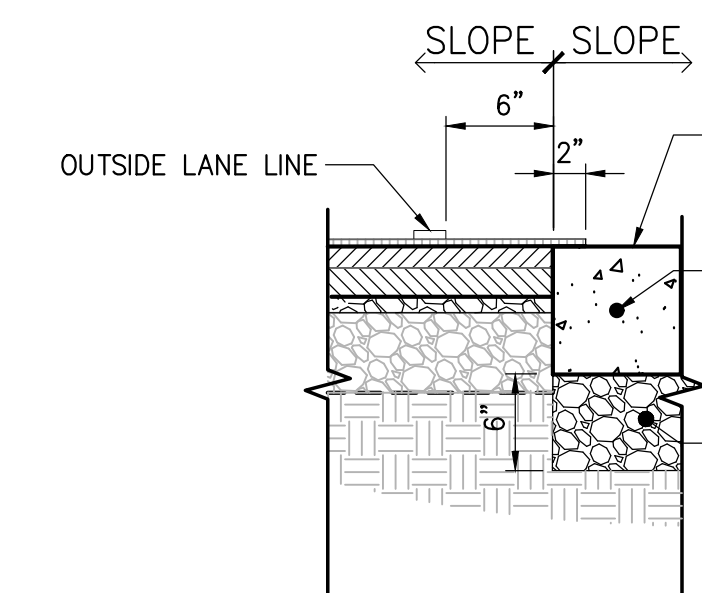


9 TRACK PERIMETER AT EXISTING CONCRETE

SCALE: NTS

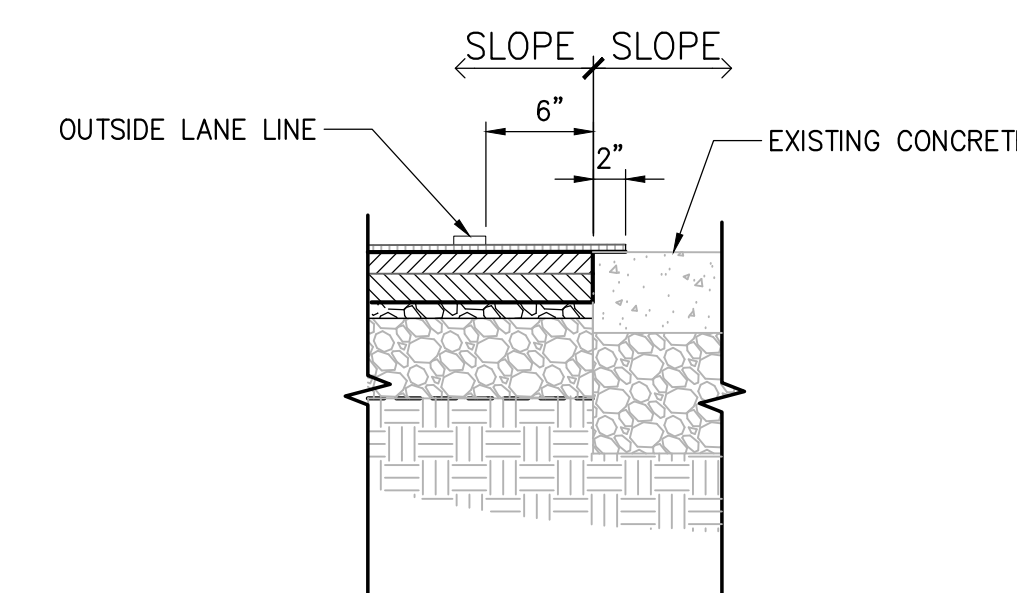


10 TRACK PERIMETER AT EXISTING WALL

SCALE: NTS

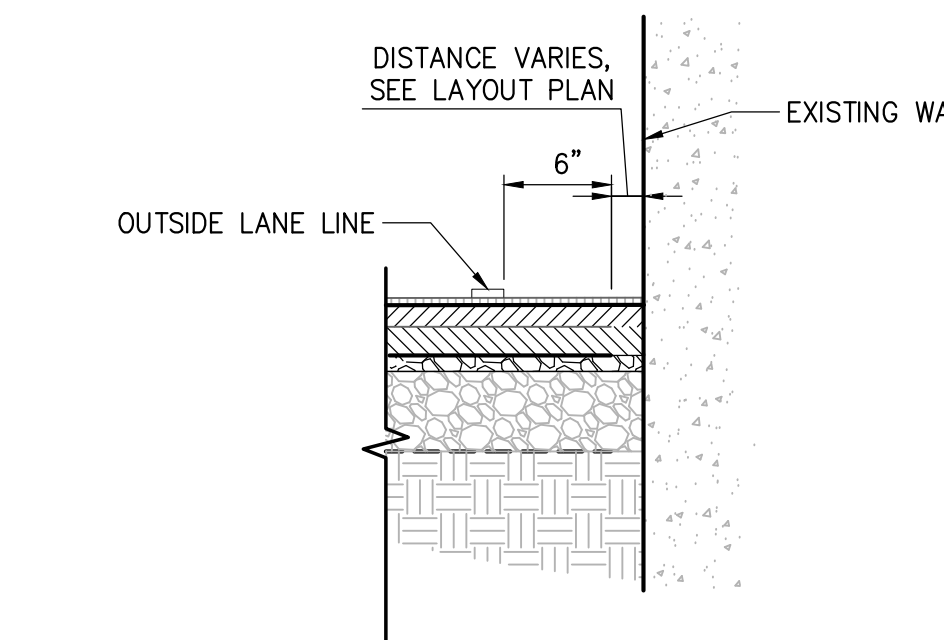


11 GRAVEL SUMP DETAIL

SCALE: NTS











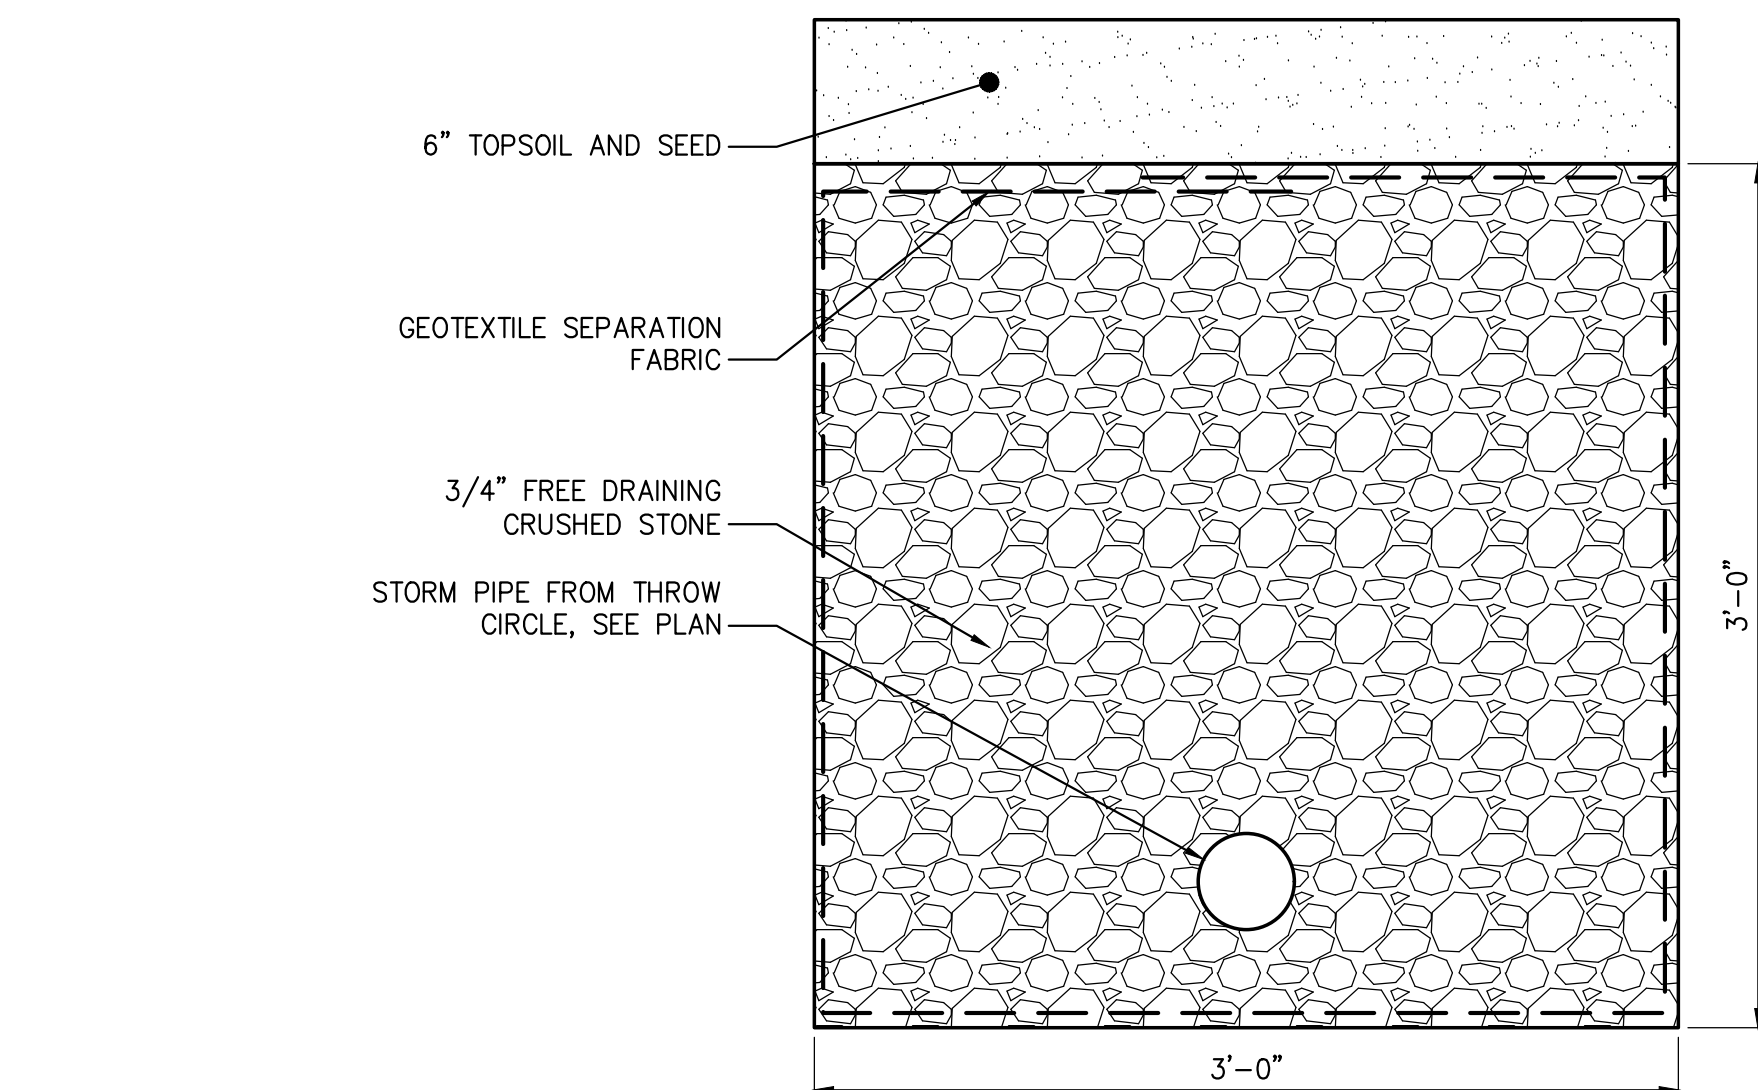


12 UNDERGROUND DETENTION FACILITY

SCALE: NTS

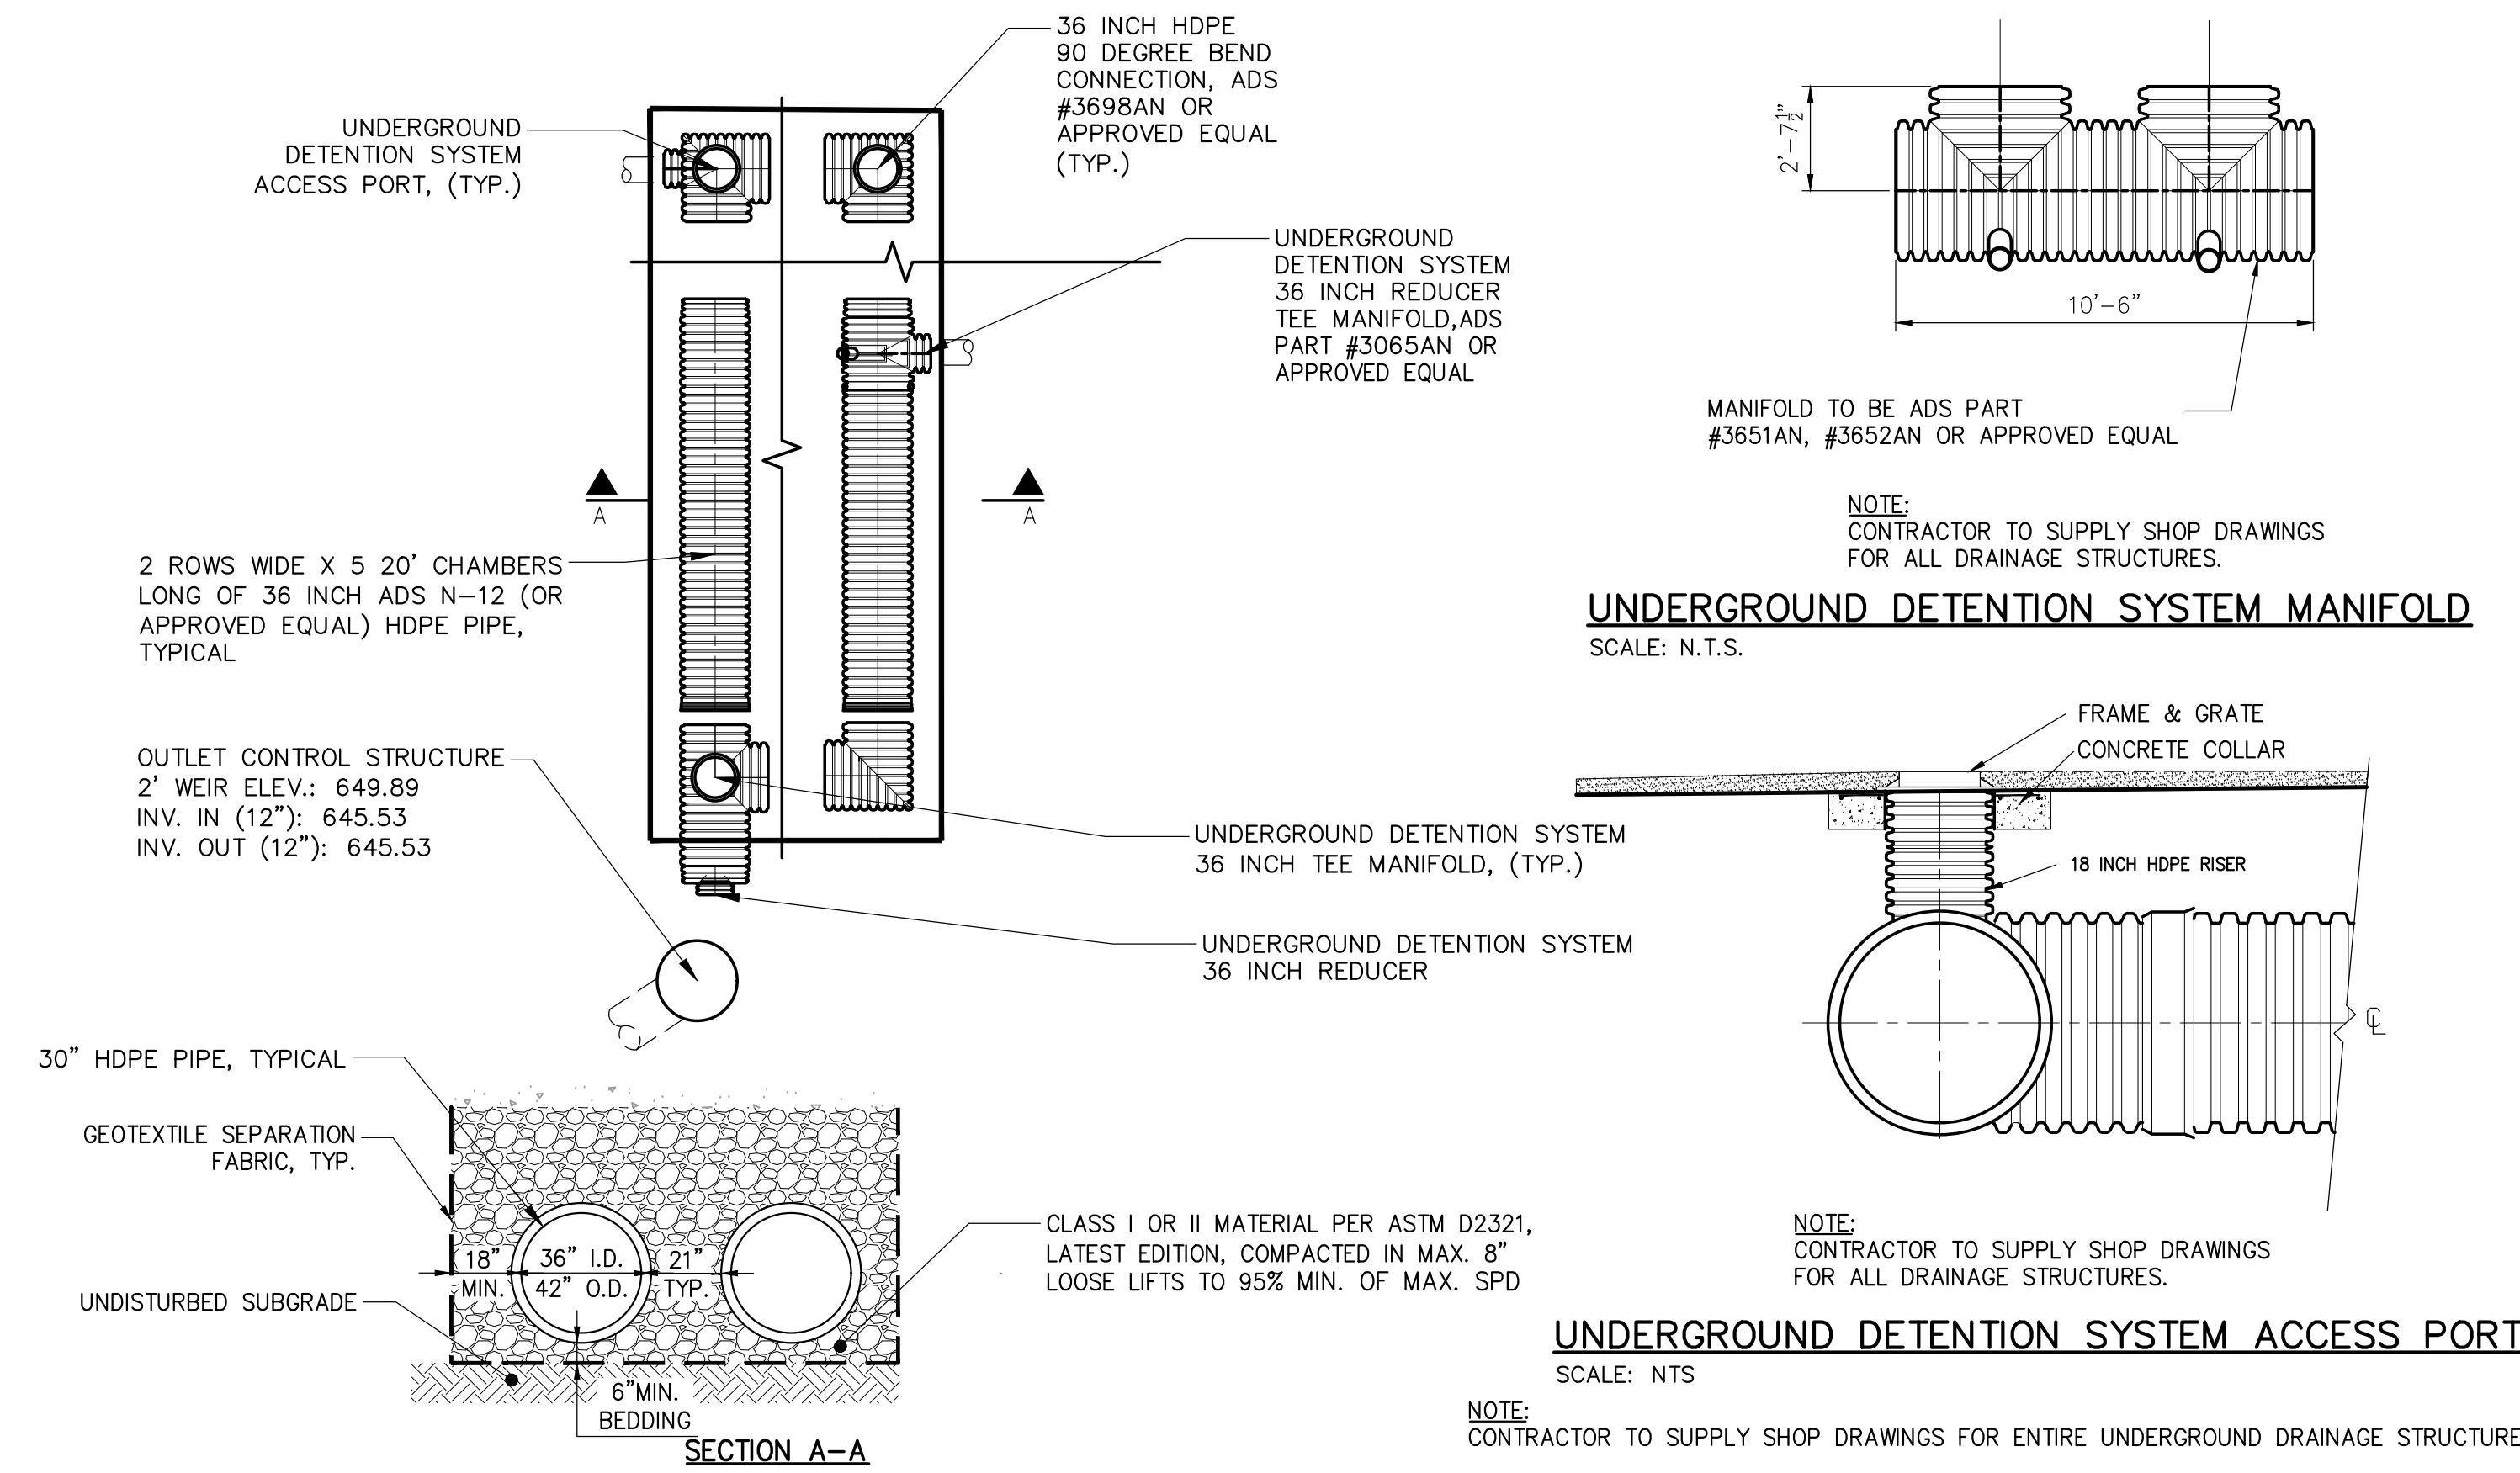



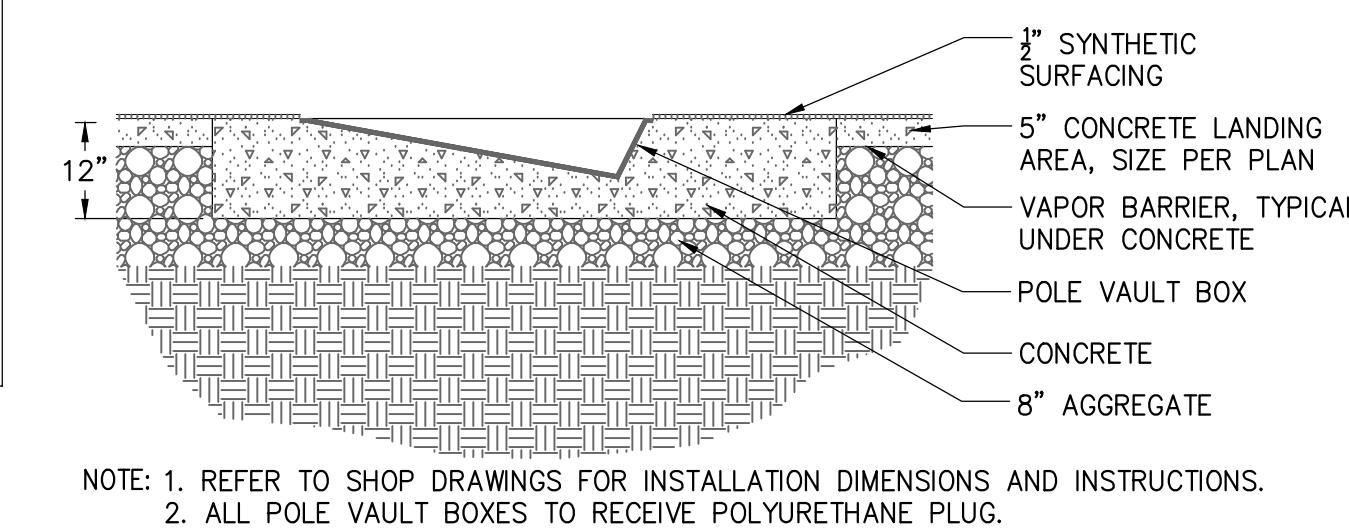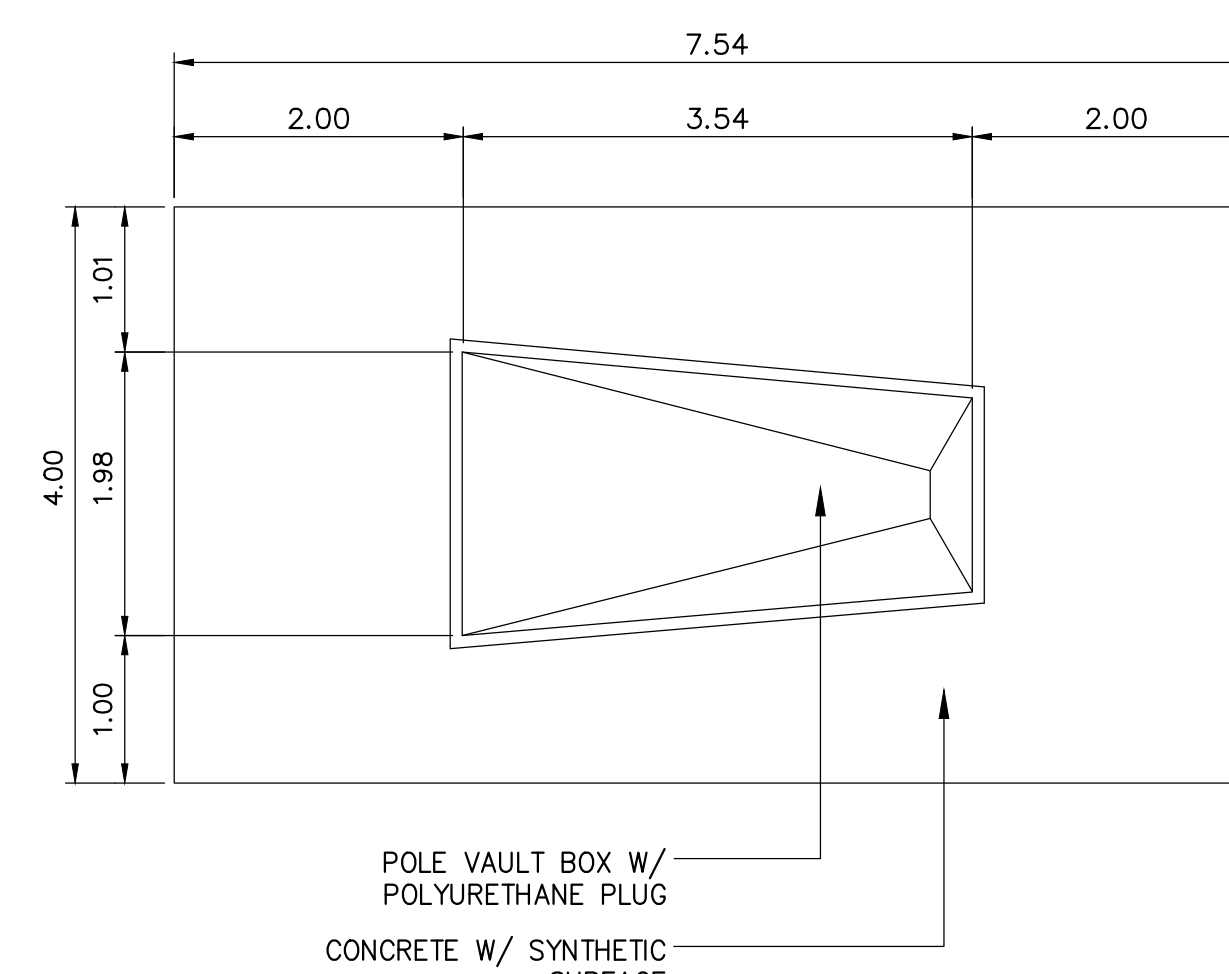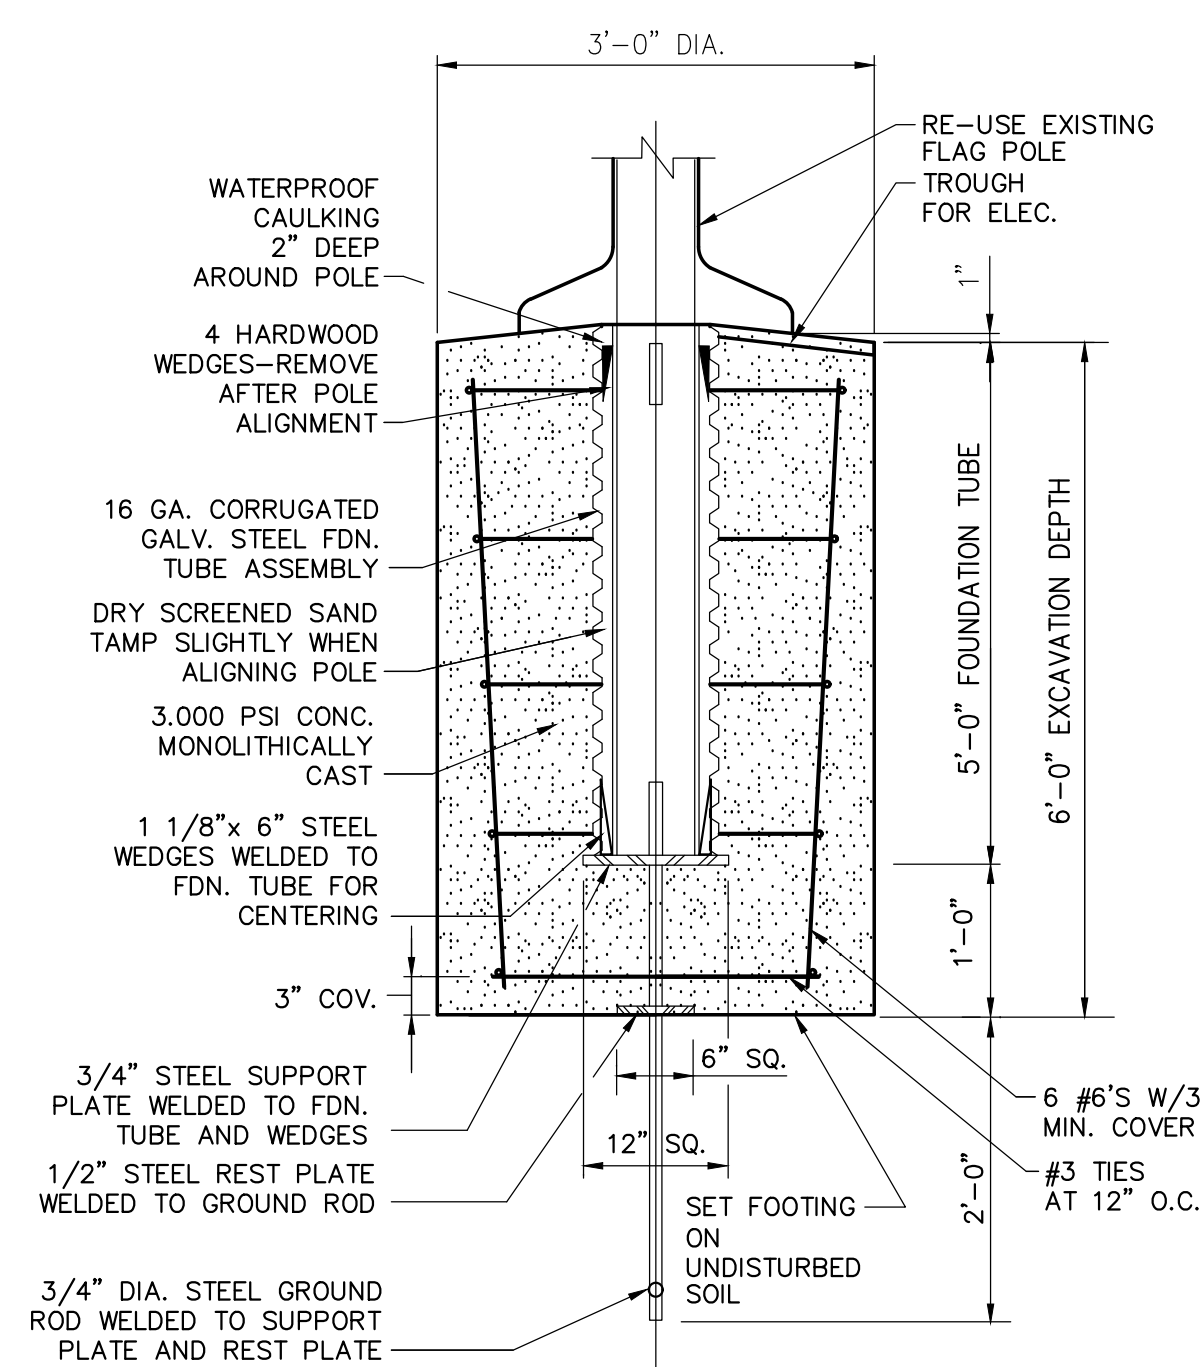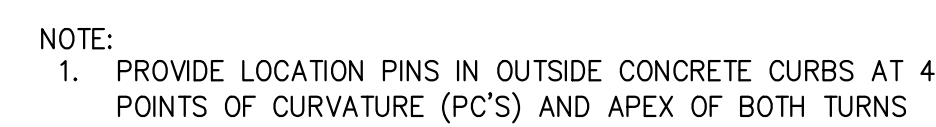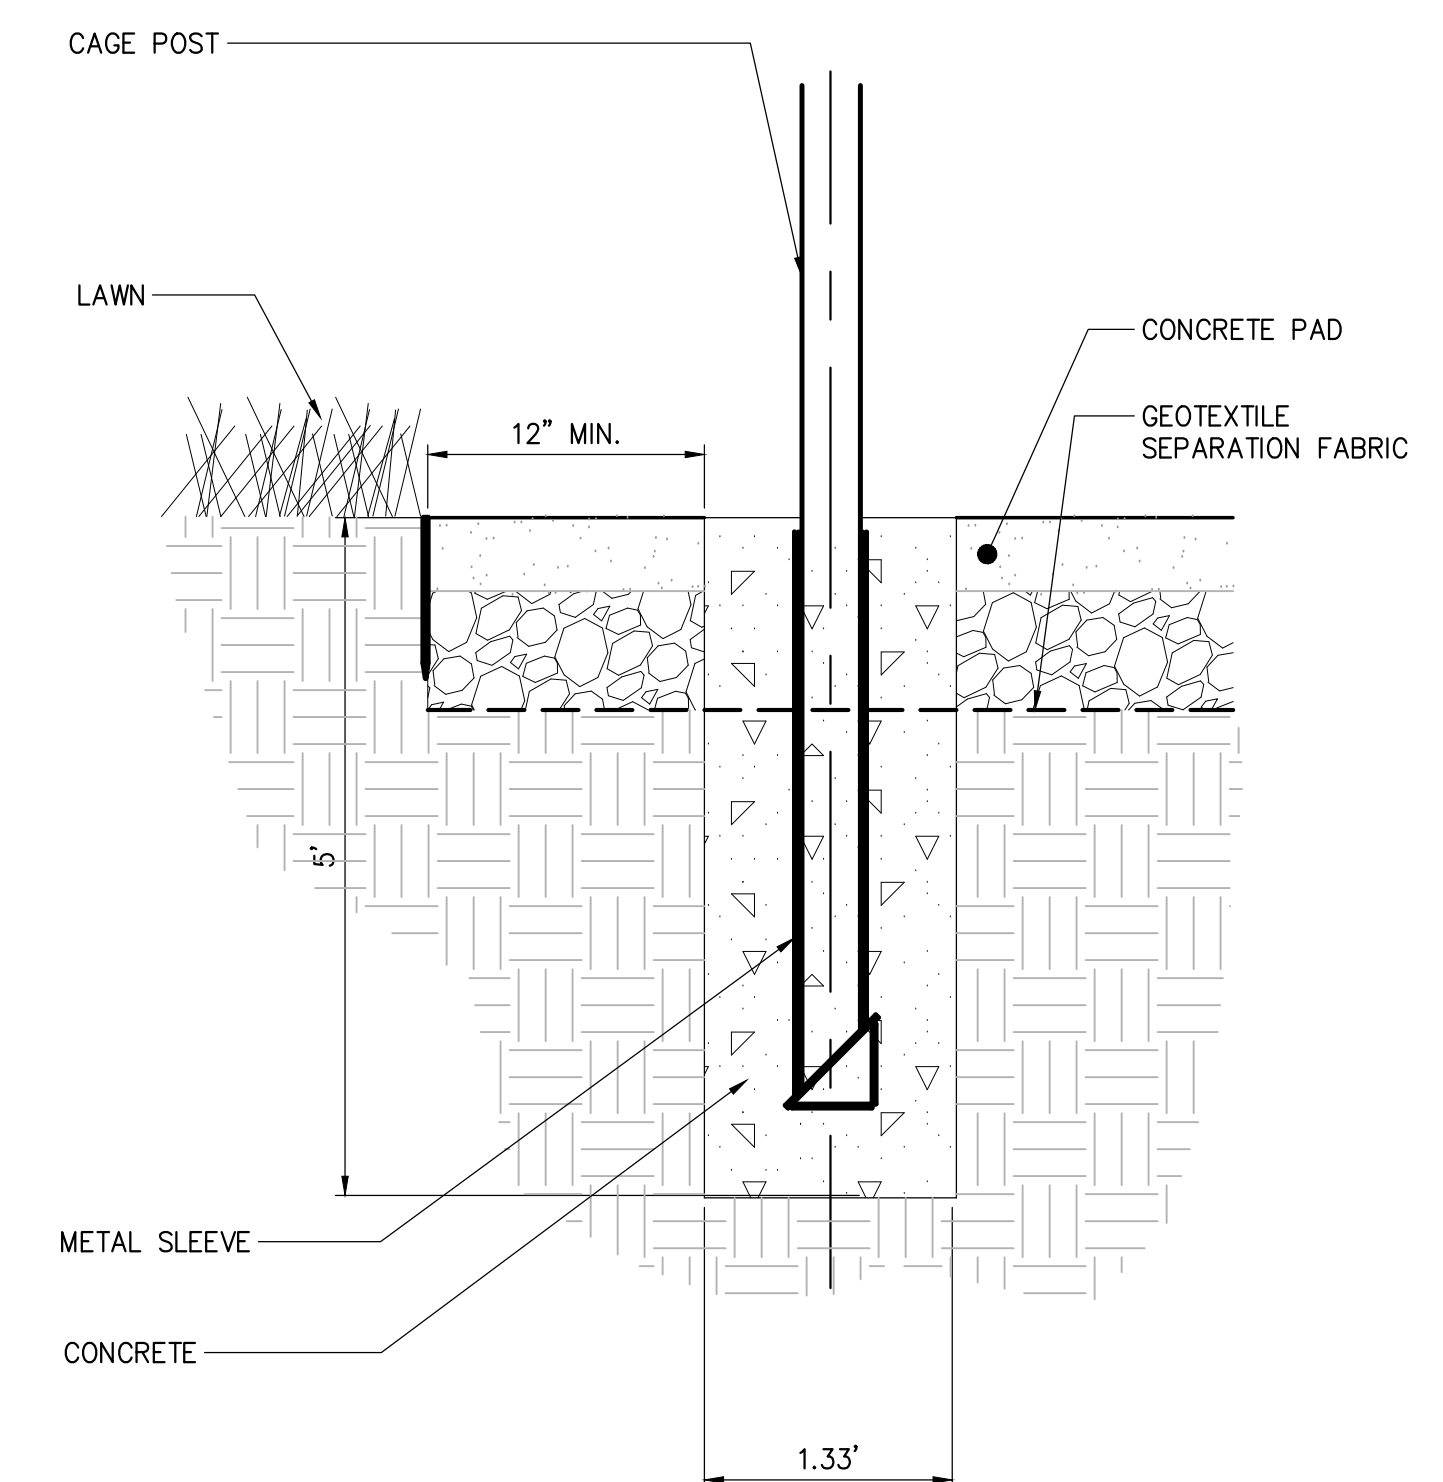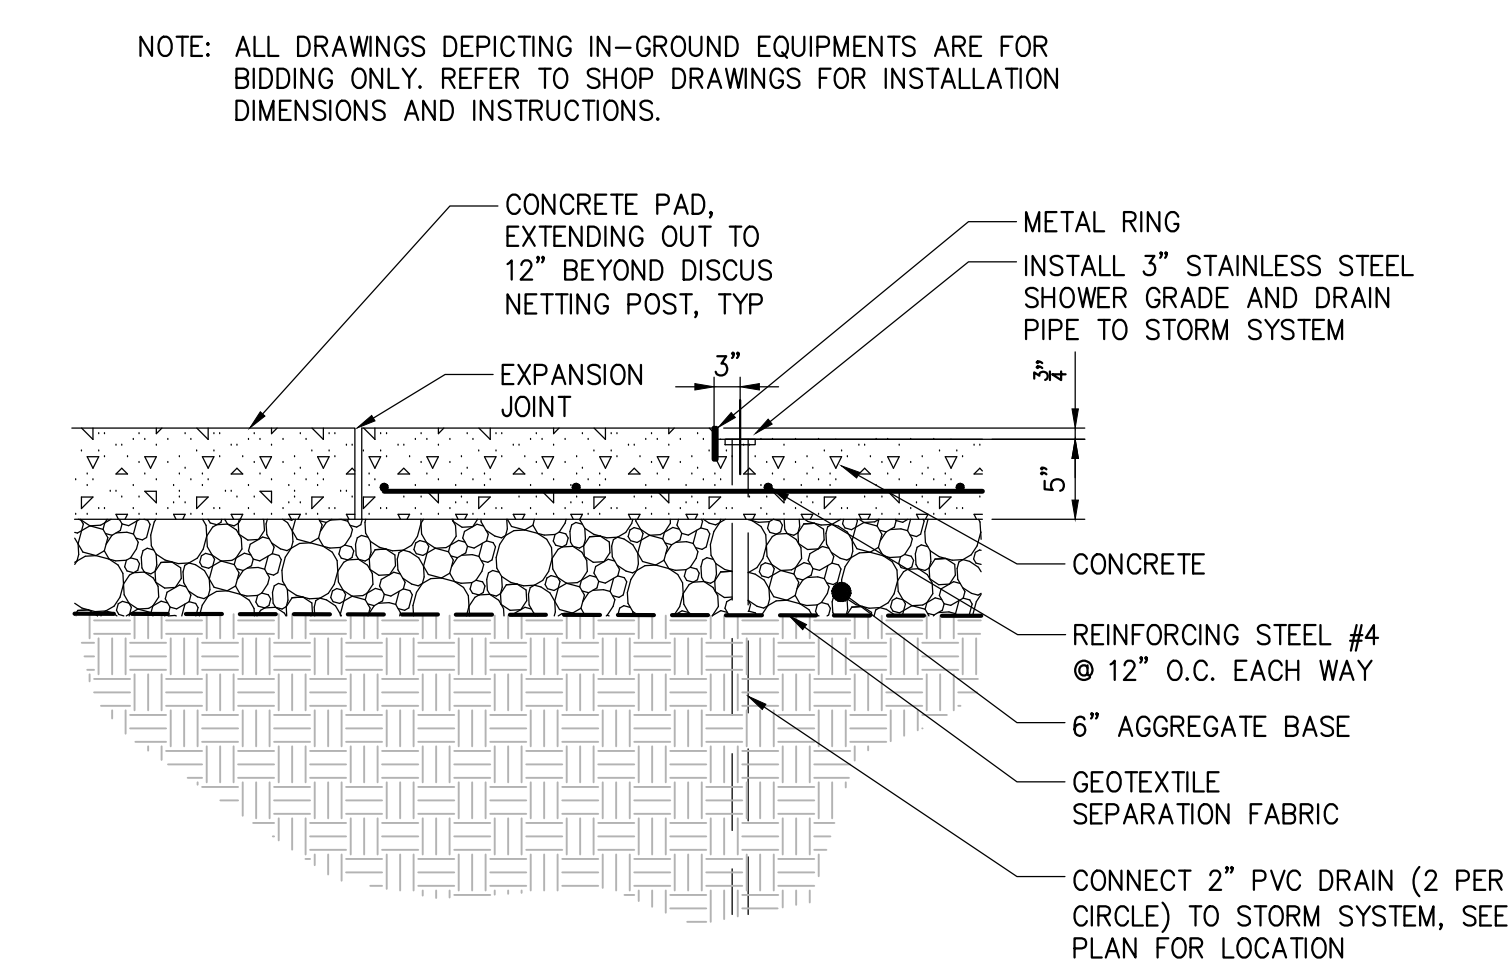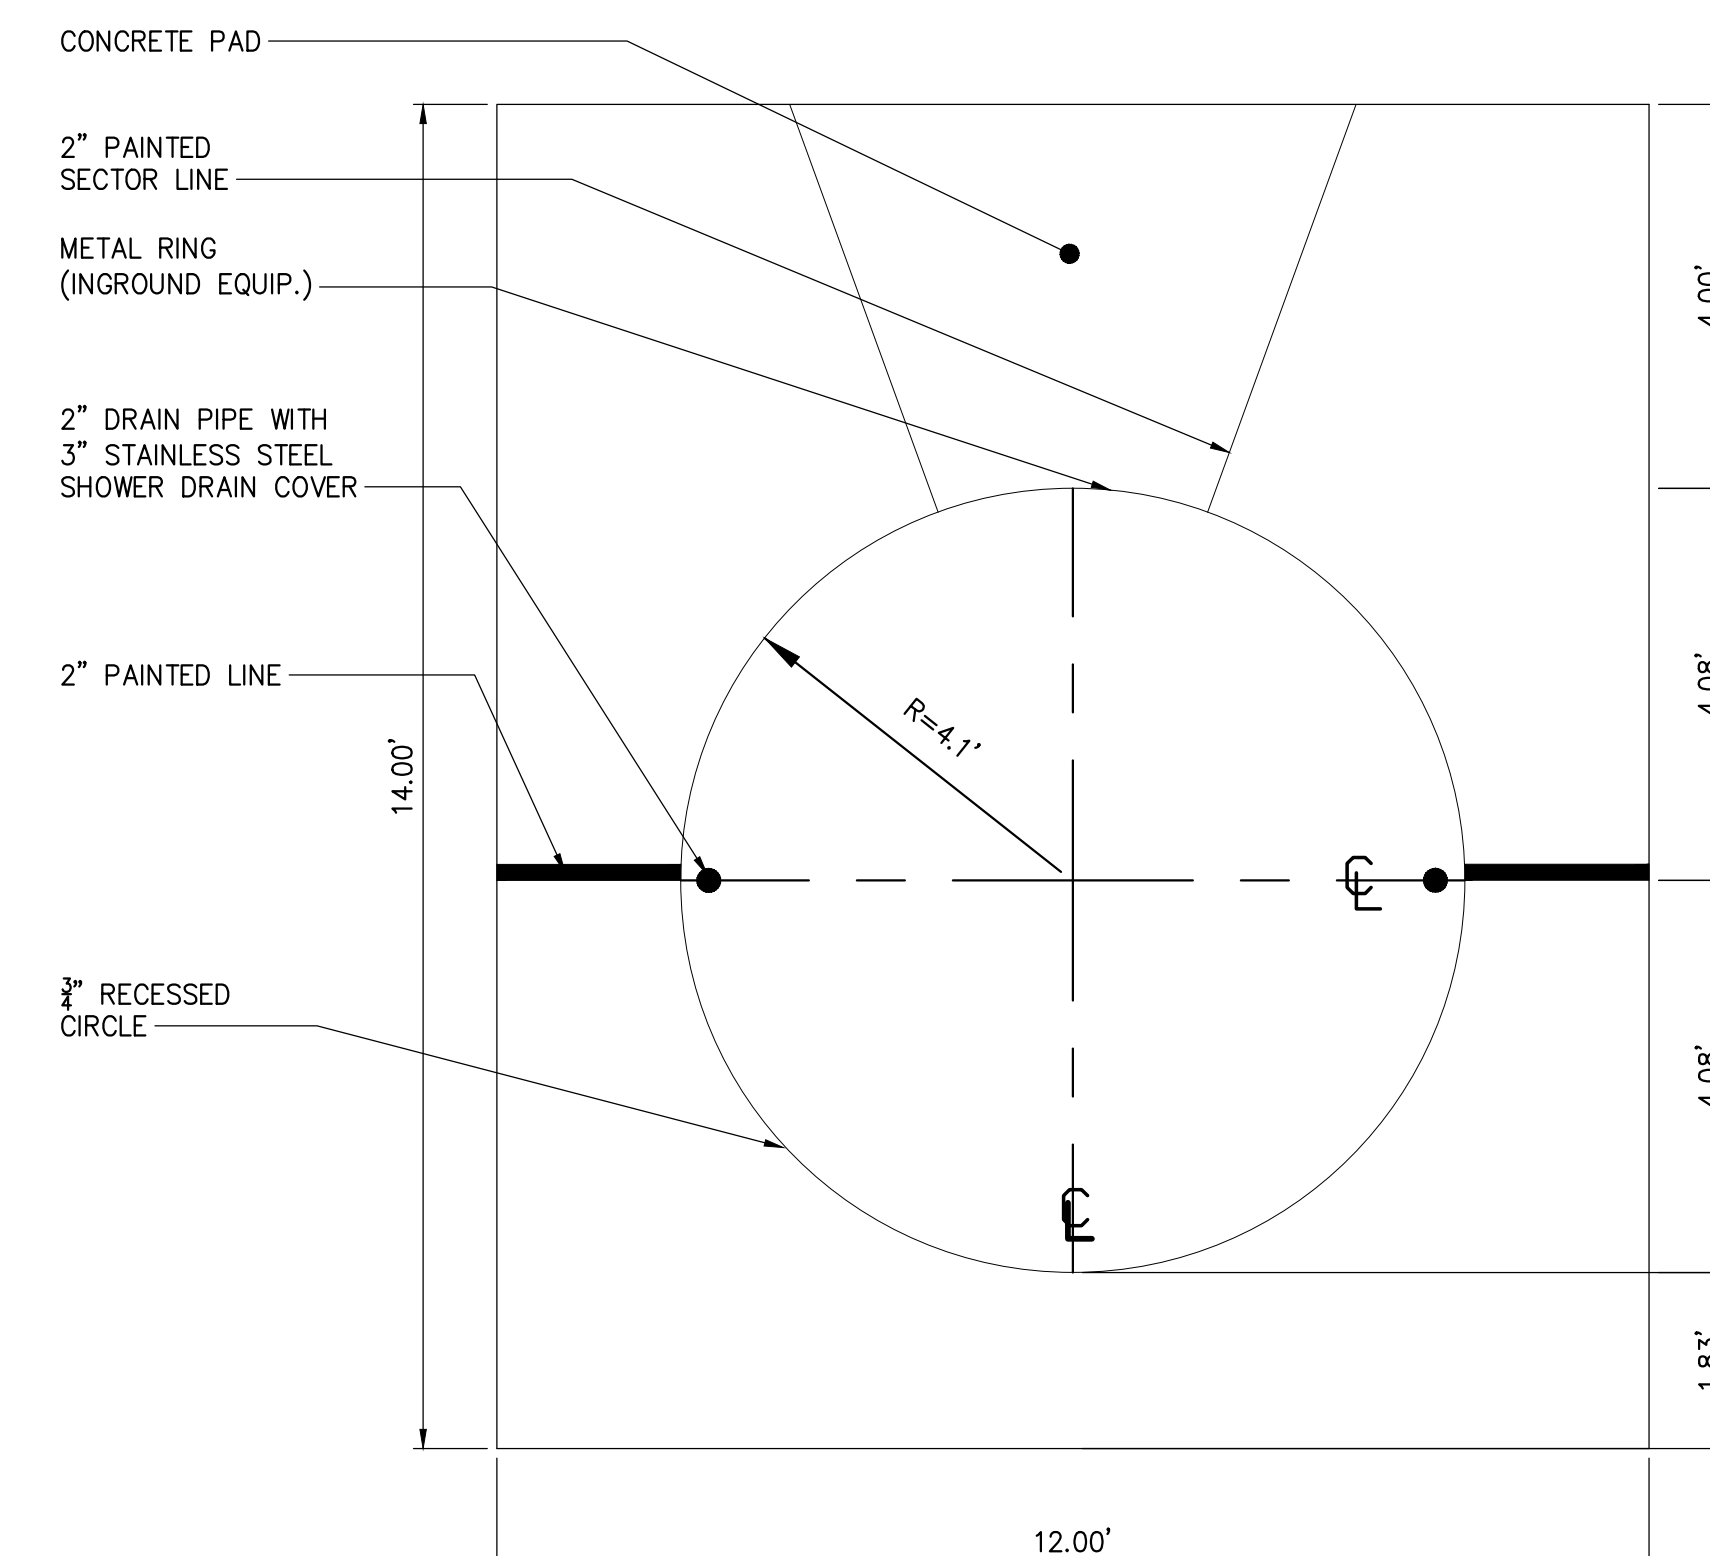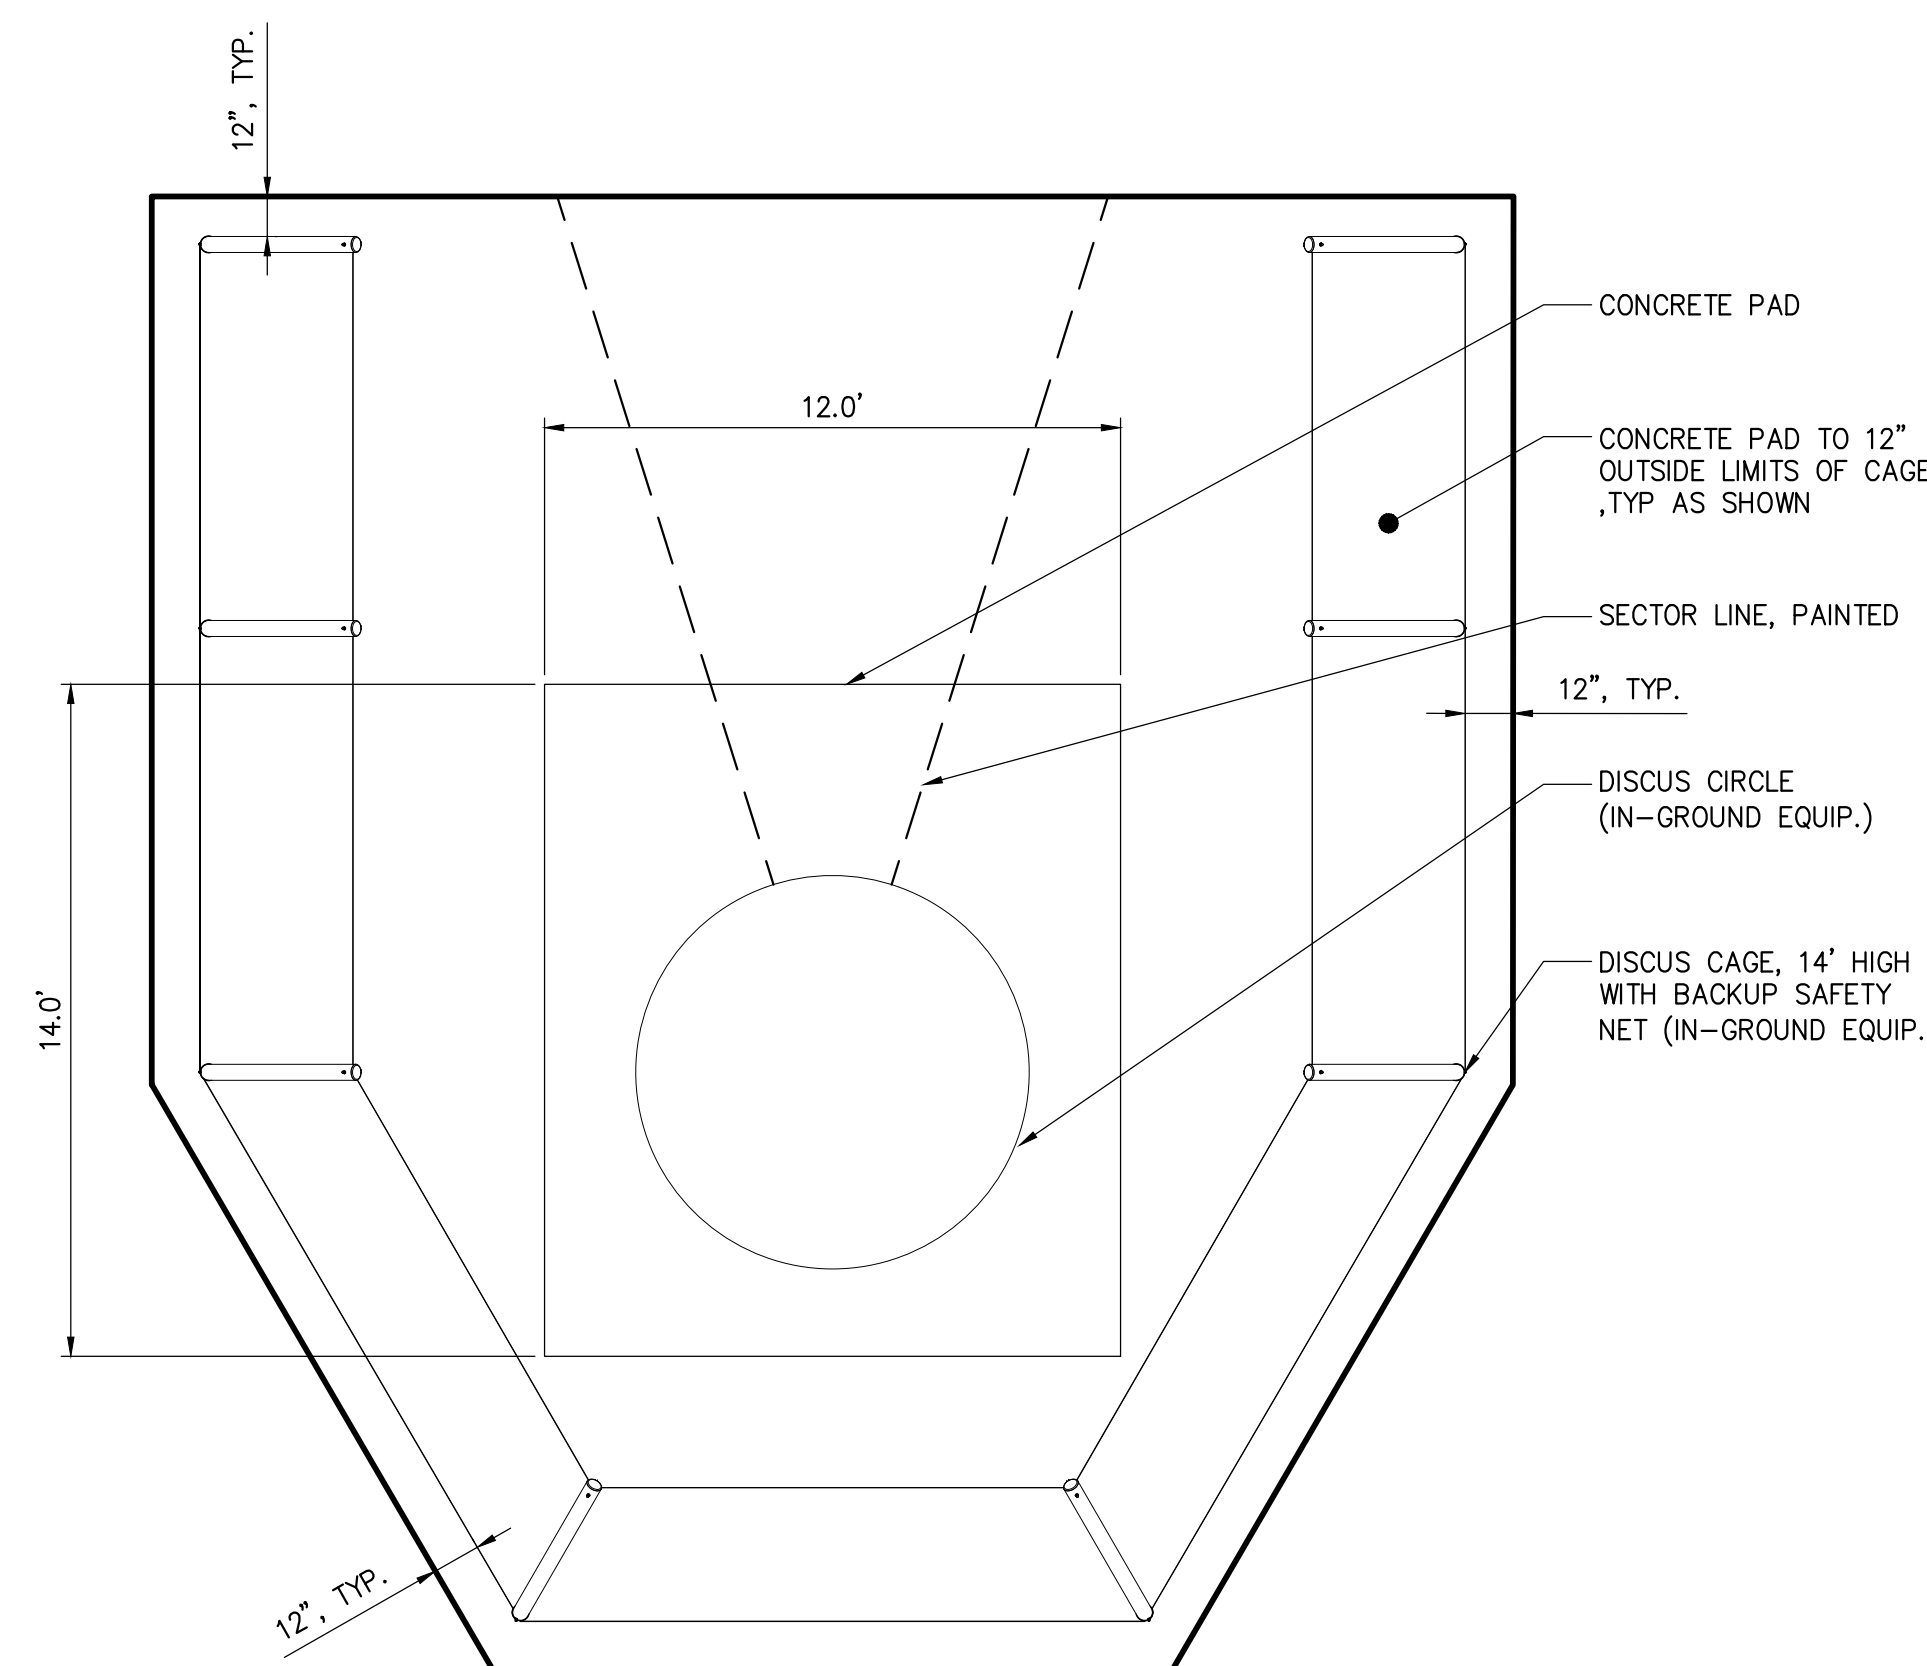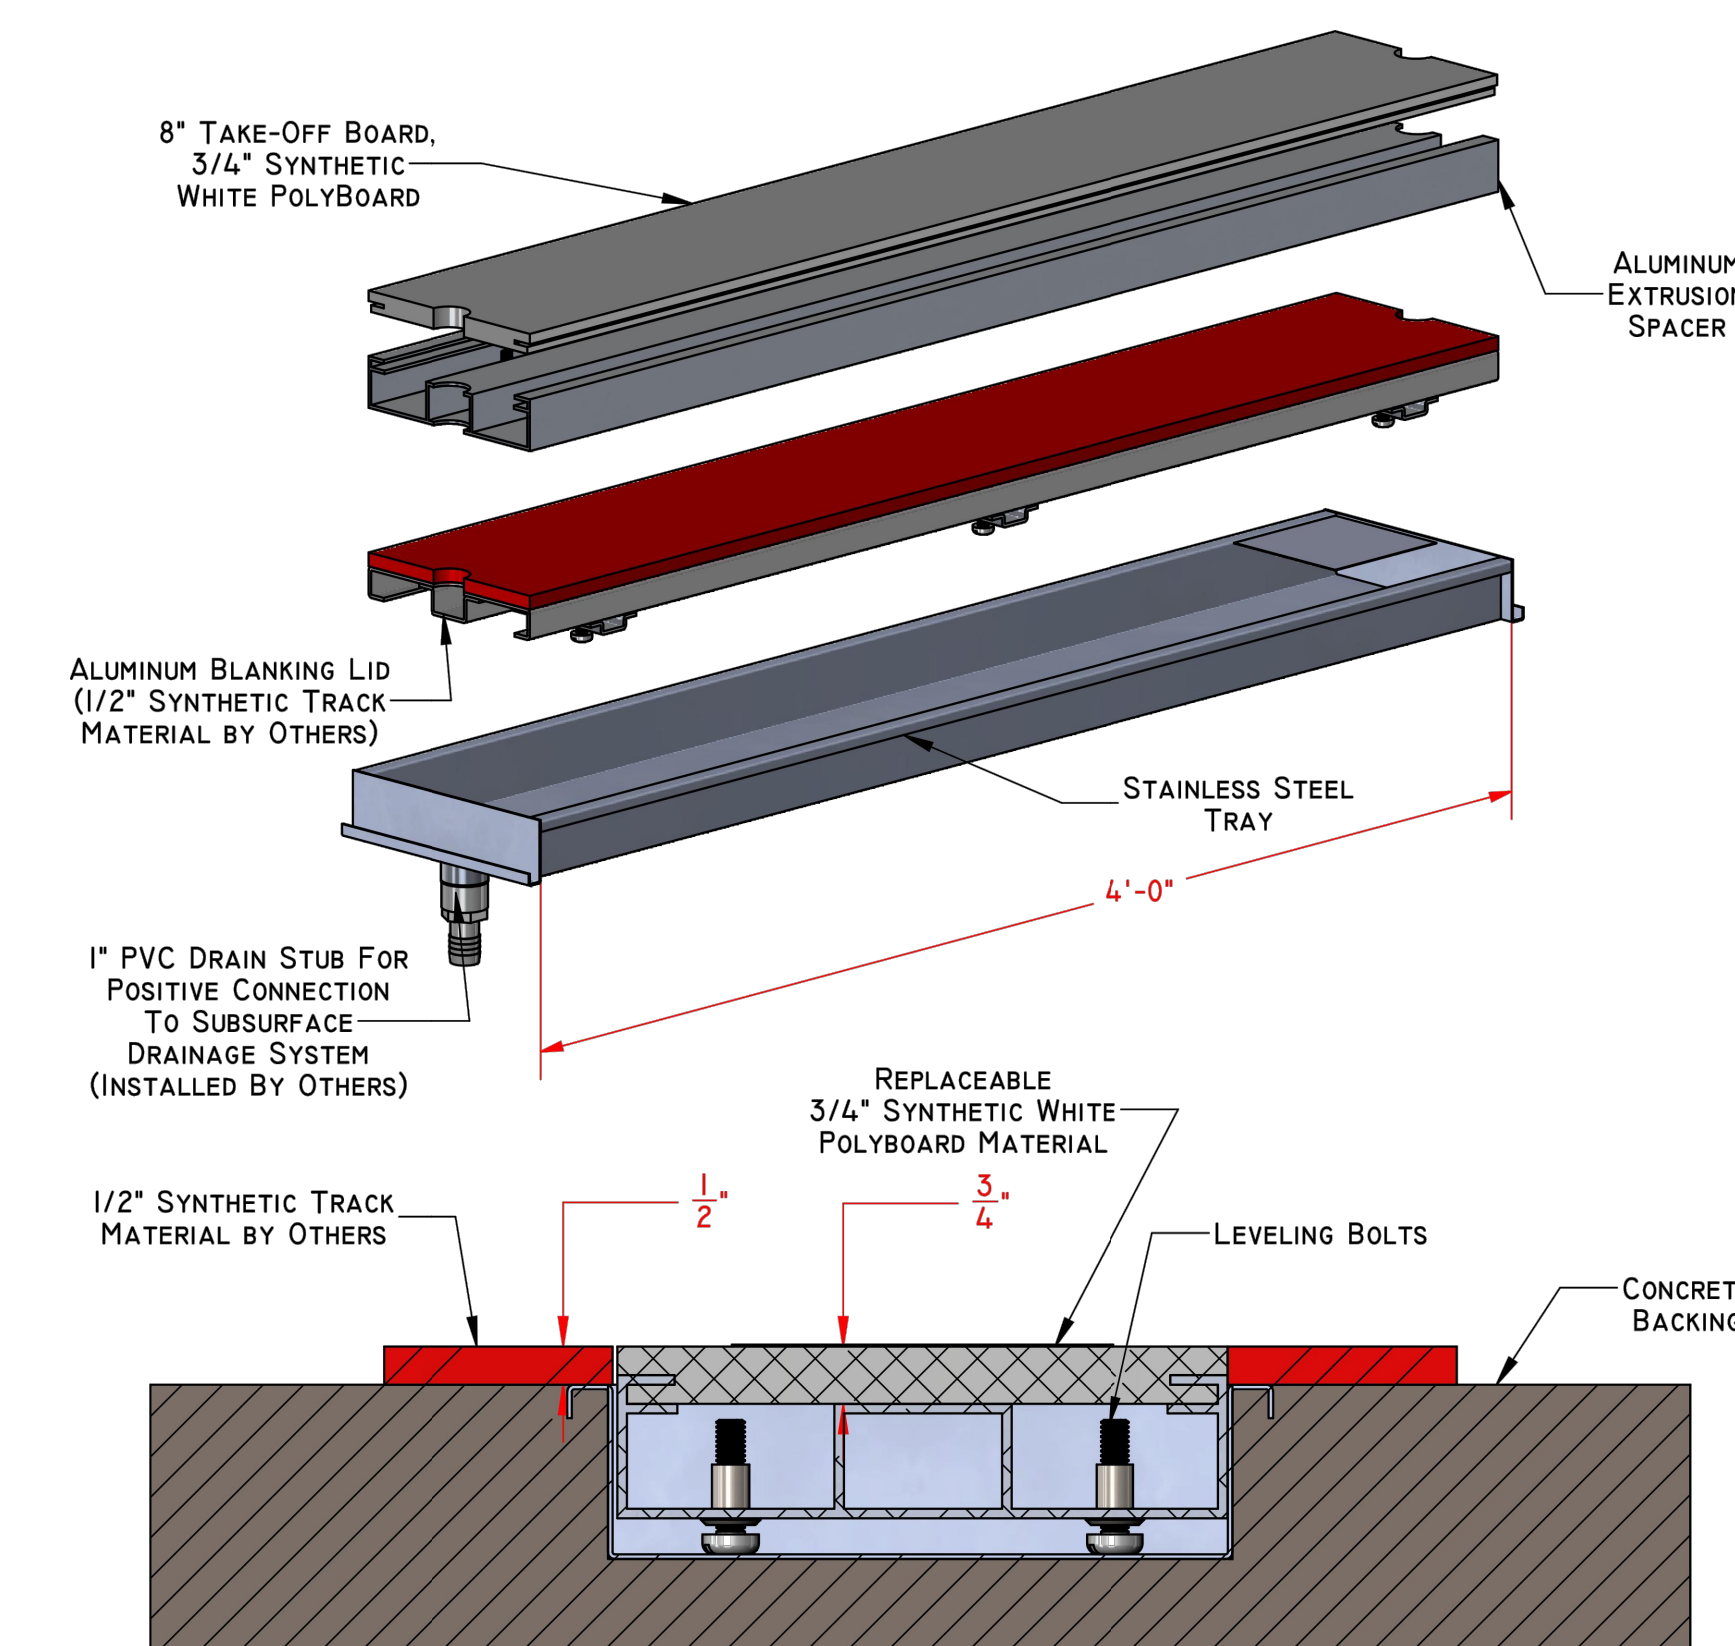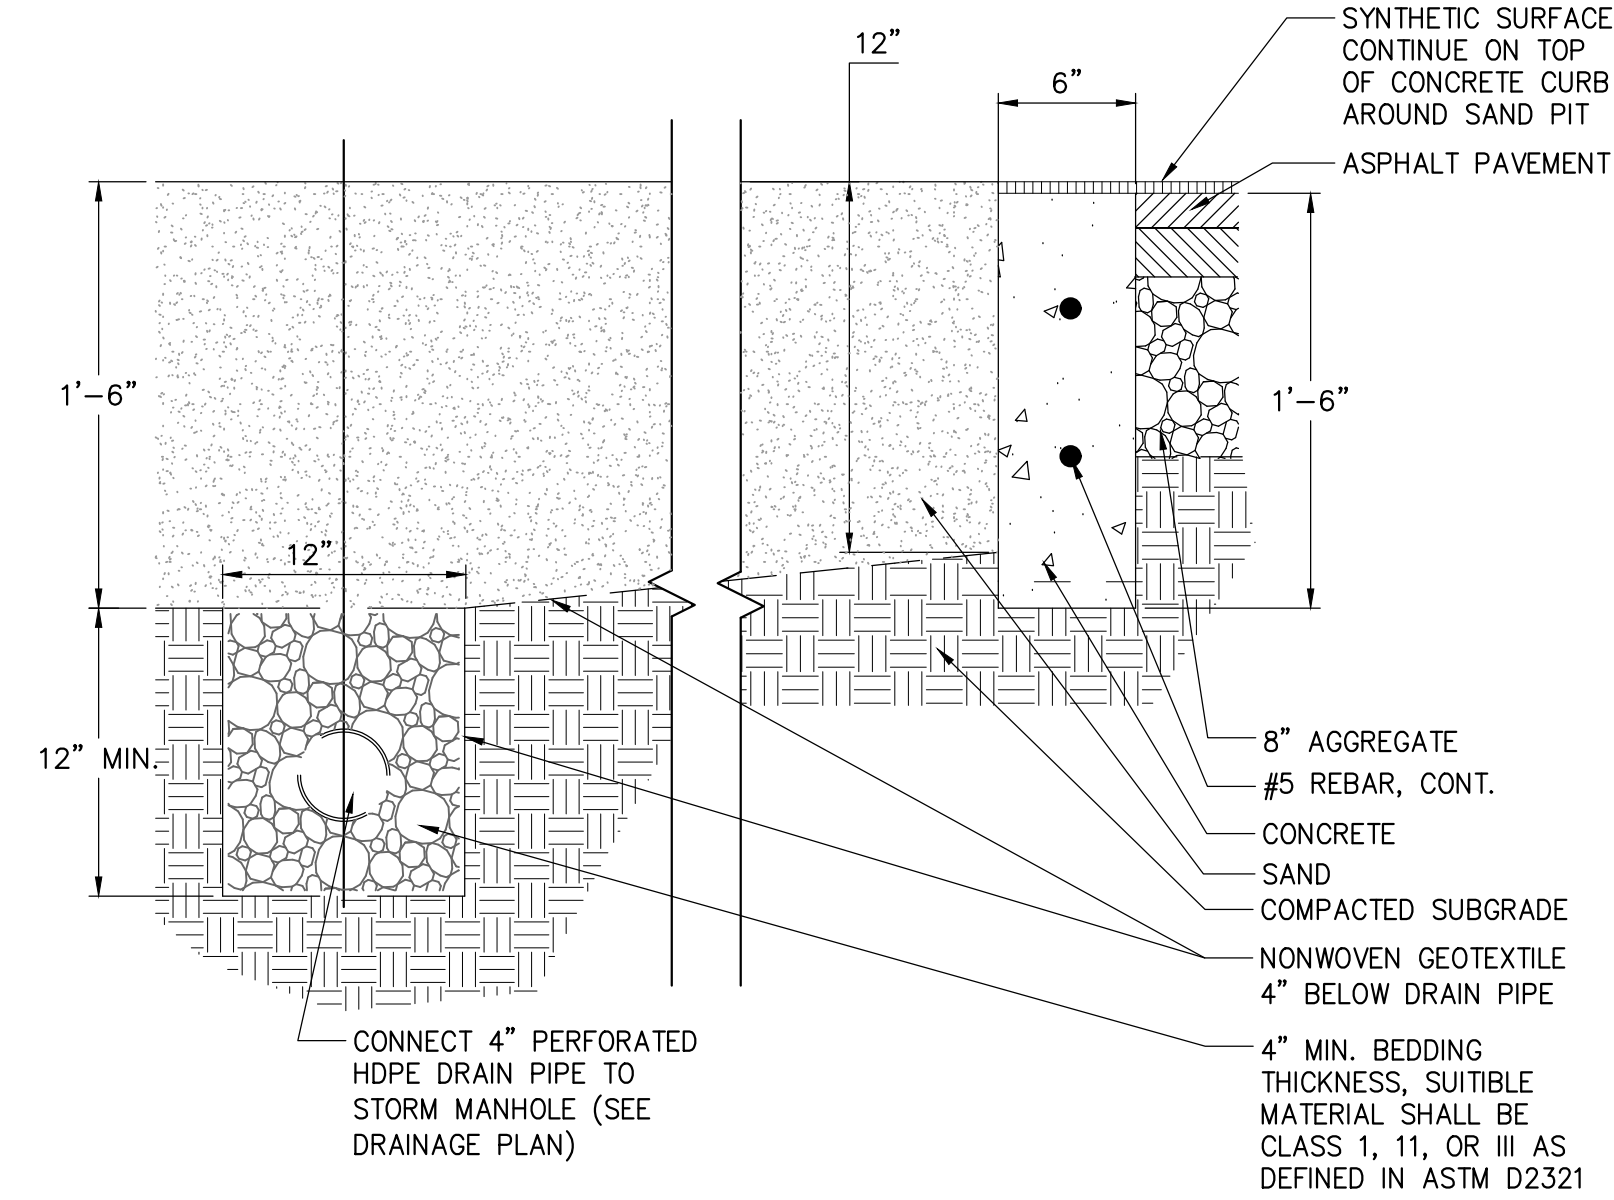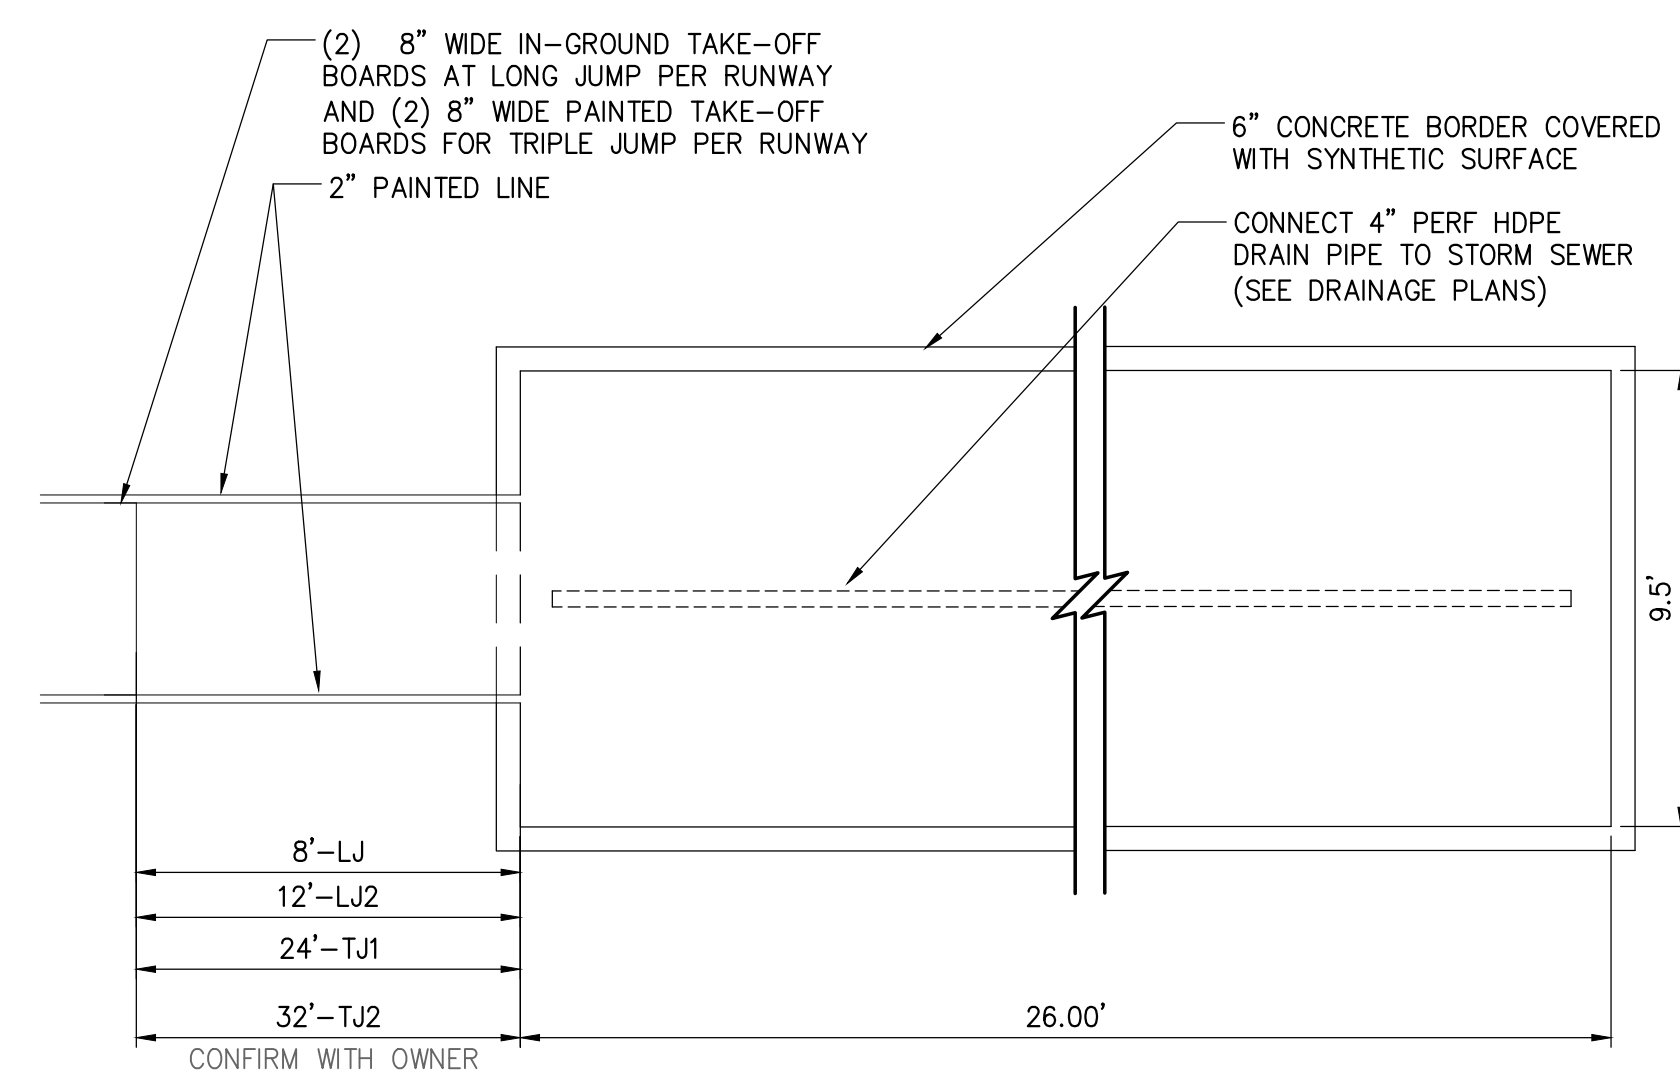

| Submittal / Revision | App | By | Date |
|----------------------|-----|----|----------|
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| BID DOCUMENTS | CL | DC | 02/09/15 |