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SHEET NAME:

COVER

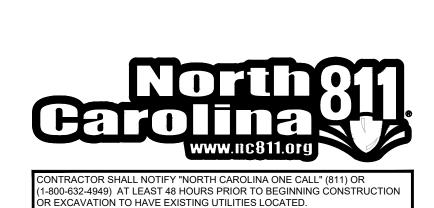
SHEET NO:

PROVIDENCE HIGH SCHOOL TRACK RENOVATIONS

CHARLOTTE, NC

| SHEET TITLE | SHEET NO. |
|-----------------------------------|-----------|
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| Throwing Events Demolition Plan | C103 |
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CONTRACTOR SHALL CONTACT ANY LOCAL UTILITIES THAT PROVIDE THEIR

DWN LOCATOR SERVICES INDEPENDENT OF "NORTH CAROLINA ONE CALL"
REPORT ANY DISCREPANCIES TO THE ENGINEER IMMEDIATELY.

VICINITY MAP (NOT TO SCALE)

Owner

Charlotte Mecklenburg Board of Education 4421 Stuart Andrew Boulevard

Charlotte, NC 28217 Contact: Brandon Barnhill

Email: brandon.1.barnhill@cms.k12.nc.us

Landscape Architect

FitFields 314 Tom Hall Street Fort Mill, SC 29715 Contact: Dan Dodd, RLA Email: dan@fitfields.com

Civil Engineer

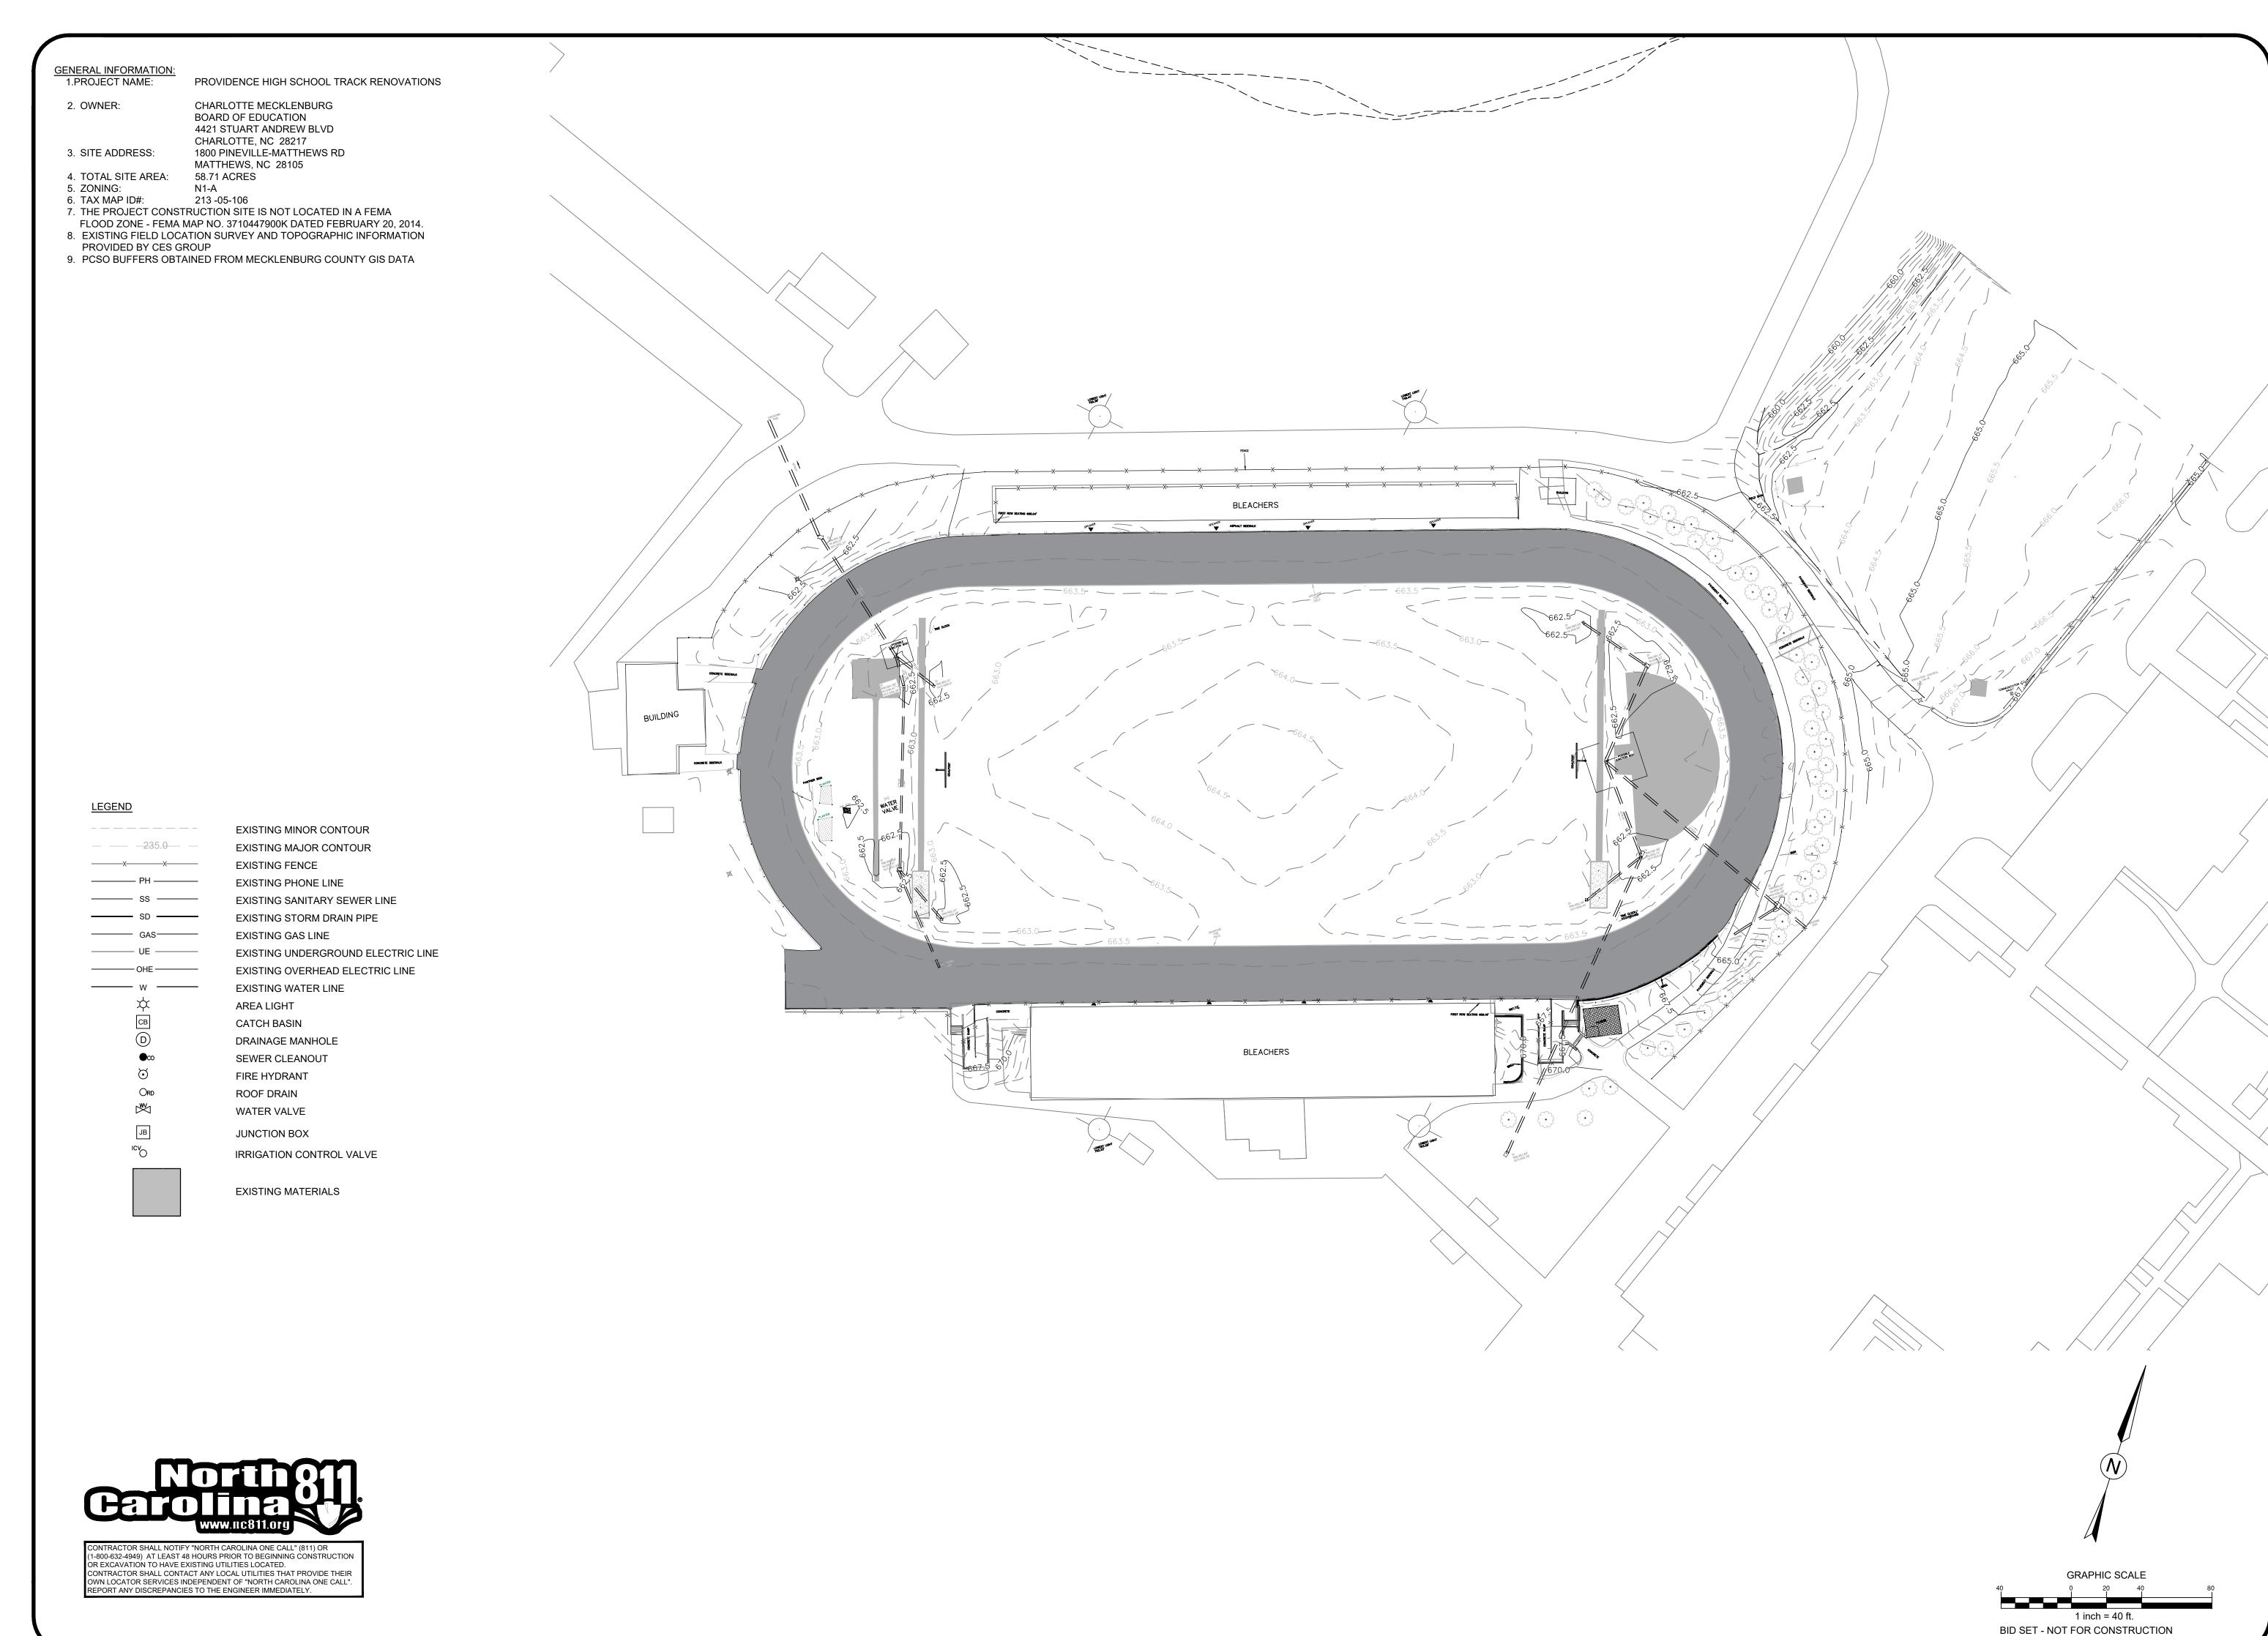
Matthew Roper, PE 3007 Hinsdale Street Charlotte, NC 28210 Contact: Matthew Roper, PE Email: matt@roperce.com



SCALE: 1" = 100'-0" DATE: 3-12-25

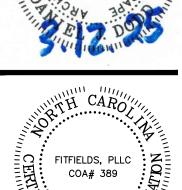
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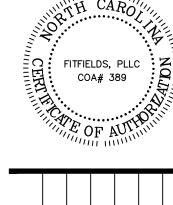
BASE MAP



314 TOM HALL ST. FORT MILL, SC 803.981.4330 FITFIELDS.com







SCALE: 1" = 40'-0" DATE: 3-12-25

SHEET NAME: **EXISTING**

SHEET NO:

CONDITIONS

DEMOLITION NOTES: 1. ALL PROPERTY AFFECTED BY THIS WORK SHALL BE RESTORED TO A CONDITION EQUAL TO OR BETTER THAN THE EXISTING UNLESS OTHERWISE SPECIFICALLY EXEMPTED BY THESE PLANS. 2. DEMOLITION DEBRIS, EXCEPT AS OTHERWISE NOTED, SHALL BECOME THE PROPERTY OF THE CONTRACTOR AND SHALL BE REMOVED FROM THE SITE. ALL DEBRIS SHALL BE DISPOSED OF OFF-SITE BY THE CONTRACTOR IN A LEGAL LANDFILL IN A TIMELY MANNER. NO SALVAGE OR SALE OF DEMOLISHED MATERIALS ON SITE WILL BE ALLOWED WITHOUT PERMISSION FROM THE OWNER. 3. REMOVE WASTE MATERIALS AND UNSUITABLE AND EXCESS TOPSOIL FROM PROPERTY AND DISPOSE OF OFF-SITE IN A LEGAL MANNER. (PERMIT REQUIRED FOR OFF-SITE DISPOSAL) 4. LOCATE EXISTING ABOVE GROUND AND UNDERGROUND UTILITIES IN AREAS OF WORK. ALL UTILITIES ARE TO REMAIN IN PLACE, PROVIDE ADEQUATE MEANS OF SUPPORT AND PROTECTION DURING DEMOLITION OPERATION. 5. SHOULD UNCHARTED, OR INCORRECTLY CHARTED PIPING OR OTHER UTILITIES BE ENCOUNTERED DURING DEMOLITION, CONSULT LANDSCAPE ARCHITECT AND UTILITY OWNER FOR IMMEDIATE ACTION. 6. DEMOLISH AND COMPLETELY REMOVE FROM SITE MATERIAL INDICATED ON PLAN OR NOTED "TO BE REMOVED". 7. PROTECT STRUCTURES, UTILITIES, SIDEWALKS, PAVEMENTS, AND OTHER FACILITIES FROM DAMAGE CAUSED BY SETTLEMENT, LATERAL MOVEMENT, UNDERMINING, WASHOUT AND OTHER HAZARDS CREATED BY THE DEMOLITION OPERATION. 8. CONTRACTOR SHALL RESTORE ALL DISTURBED AREAS TO EXISTING CONDITIONS OR 9. CONTRACTOR SHALL MAINTAIN POSITIVE STORM DRAINAGE DURING CONSTRUCTION TO INSURE NO DAMAGE TO ADJACENT PROPERTIES OCCURS DURING STORM - EX. CHAIN LINK TO VISITOR BLEACHERS 10. CONTRACTOR SHALL COORDINATE STORM DEMOLITION WITH STORM DRAIN BE REMOVED TO REMAIN BLEACHERS IMPROVEMENTS TO MAINTAIN POSITIVE DRAINAGE. FIRST ROW SEATING 665. 11. THE CONTRACTOR IS RESPONSIBLE FOR LOCATING AND PROTECTING ALL EXISTING UTILITIES. 12. ALL DEMOLITION AND CONSTRUCTION SHALL COMPLY WITH APPLICABLE BUILDING CODES AND LOCAL RESTRICTIONS. THE CONTRACTOR MUST COMPLY WITH ALL OF THE CONTRACTOR REGISTRATION REQUIREMENTS OF ALL GOVERNING AUTHORITIES. 13.PRIOR TO THE COMMENCEMENT OF DEMOLITION, THE CONTRACTOR SHALL COORDINATE HIS ACTIVITIES WITH ALL UTILITY COMPANIES SERVING THIS AREA. THE CONTRACTOR IS TO COORDINATE FULLY WITH THE UTILITY COMPANIES ON THE EXACT LOCATION OF ALL UNDERGROUND UTILITIES PRIOR TO DEMOLITION, CONSTRUCTION, AND EXCAVATION. EX. PLAY CLOCK EX/CHAIN LINK/TO 14. ALL PROPOSED PAVEMENT CUTS SHALL BE SAW CUT ONLY. TO BE RELOCATED / BÉ REMOVED 15. CONTRACTOR SHALL PROVIDE A MINIMUM OF 72 HOURS ADVANCE NOTICE TO THE -EXISTING OWNER PRIOR TO STARTING DEMOLITION ACTIVITIES. 16. CONTRACTOR SHALL VERIFY AND PROTECT ALL PUBLIC UTILITIES. ANY WORK CONC. CURBS EX. POLE VAULT ASSOCIATED WITH SAID UTILITIES TO BE COORDINATED WITH APPROPRIATE UTILITY TO BE REMOVED BOX TO REMOVED COMPANY. DEMOLITION OF UTILITIES WHICH ARE ACTIVE SHALL BE SEQUENCED TO ALLOW FOR INSTALLATION OF NEW OR REROUTED LINES, PRIOR TO REMOVAL OF **EXISTING UTILITIES** EXISTING PORTION. TO REMAIN AND BE PROTECTED 17. THE CONTRACTOR SHALL IMMEDIATELY REPORT TO THE OWNER AND LANDSCAPE ARCHITECT ANY DISCREPANCIES FOUND BETWEEN ACTUAL FIELD CONDITIONS AND CONSTRUCTION DOCUMENTS AND SHALL WAIT FOR INSTRUCTIONS PRIOR TO PROCEEDING. BUILDING 18.PRIOR TO BEGINNING CONSTRUCTION THE CONTRACTOR IS RESPONSIBLE TO VERIFY EX. PANTHER ŞIĞN TO REMAIN THAT ALL REQUIRED PERMITS AND APPROVALS HAVE BEEN OBTAINED FROM ALL EX. LANDSCAPE PLANTERS TO REMAIN REGULATORY AUTHORITIES AND SHALL BE THOROUGHLY FAMILIAR WITH CONDITIONS OF SAID PERMITS AND INSPECTION REQUIREMENTS. 19. THE CONTRACTOR SHALL CONTACT ALL OWNERS OF EASEMENTS, UTILITIES AND EX. CATCH BASIN TO REMAIN RIGHT-OF-WAYS, PUBLIC OR PRIVATE, PRIOR TO WORKING IN THESE AREAS. 20. THE CONTRACTOR SHALL BE RESPONSIBLE FOR DAMAGE TO ANY EXISTING ITEM

AND/OR MATERIAL INSIDE OR OUTSIDE THE CONSTRUCTION LIMITS. 21.CONTRACTOR SHALL MAINTAIN THE SITE IN A MANNER SO THAT WORKMEN AND PUBLIC ARE PROTECTED FROM INJURY. 22.LANDSCAPE ARCHITECT SHALL NOT BE IN CONTROL OR CHARGE OF, AND SHALL NOT BE RESPONSIBLE FOR ACTUAL CONSTRUCTION MEANS, METHODS, TECHNIQUES, PROCEDURES, OR SAFETY PRECAUTIONS IN CONNECTION WITH THE WORK, OR FOR THE ACTS OR OMISSIONS OF CONTRACTORS OR ANY OTHER PERSONS NOT UNDER THE EMPLOYMENT OF LANDSCAPE ARCHITECT. 23.SHOULD THE CONTRACTOR ENCOUNTER ANY ADDITIONAL ITEMS THAT MAY REQUIRE DEMOLITION (FENCES, GUARD RAIL, ETC.) - THE CONTRACTOR SHALL CONTACT THE LANDSCAPE ARCHITECT FOR FURTHER DIRECTION. 24.CONTRACTOR IS RESPONSIBLE FOR MAINTAINING THE OPERATION OF THE EXISTING IRRIGATION SYSTEM AND SHALL RELOCATE ANY HEADS OR LINES THAT INTERFERE

WITH THE NEW TRACK EVENT AREAS AT THE CONTRACTORS EXPENSE.

EXISTING TRACK SURFACE TO BE REMOVED. EXISTING BASE CAN BE REUSED WHERE APPLICABLE. EXISTING CONCRETE CURB TO BE REMOVED.

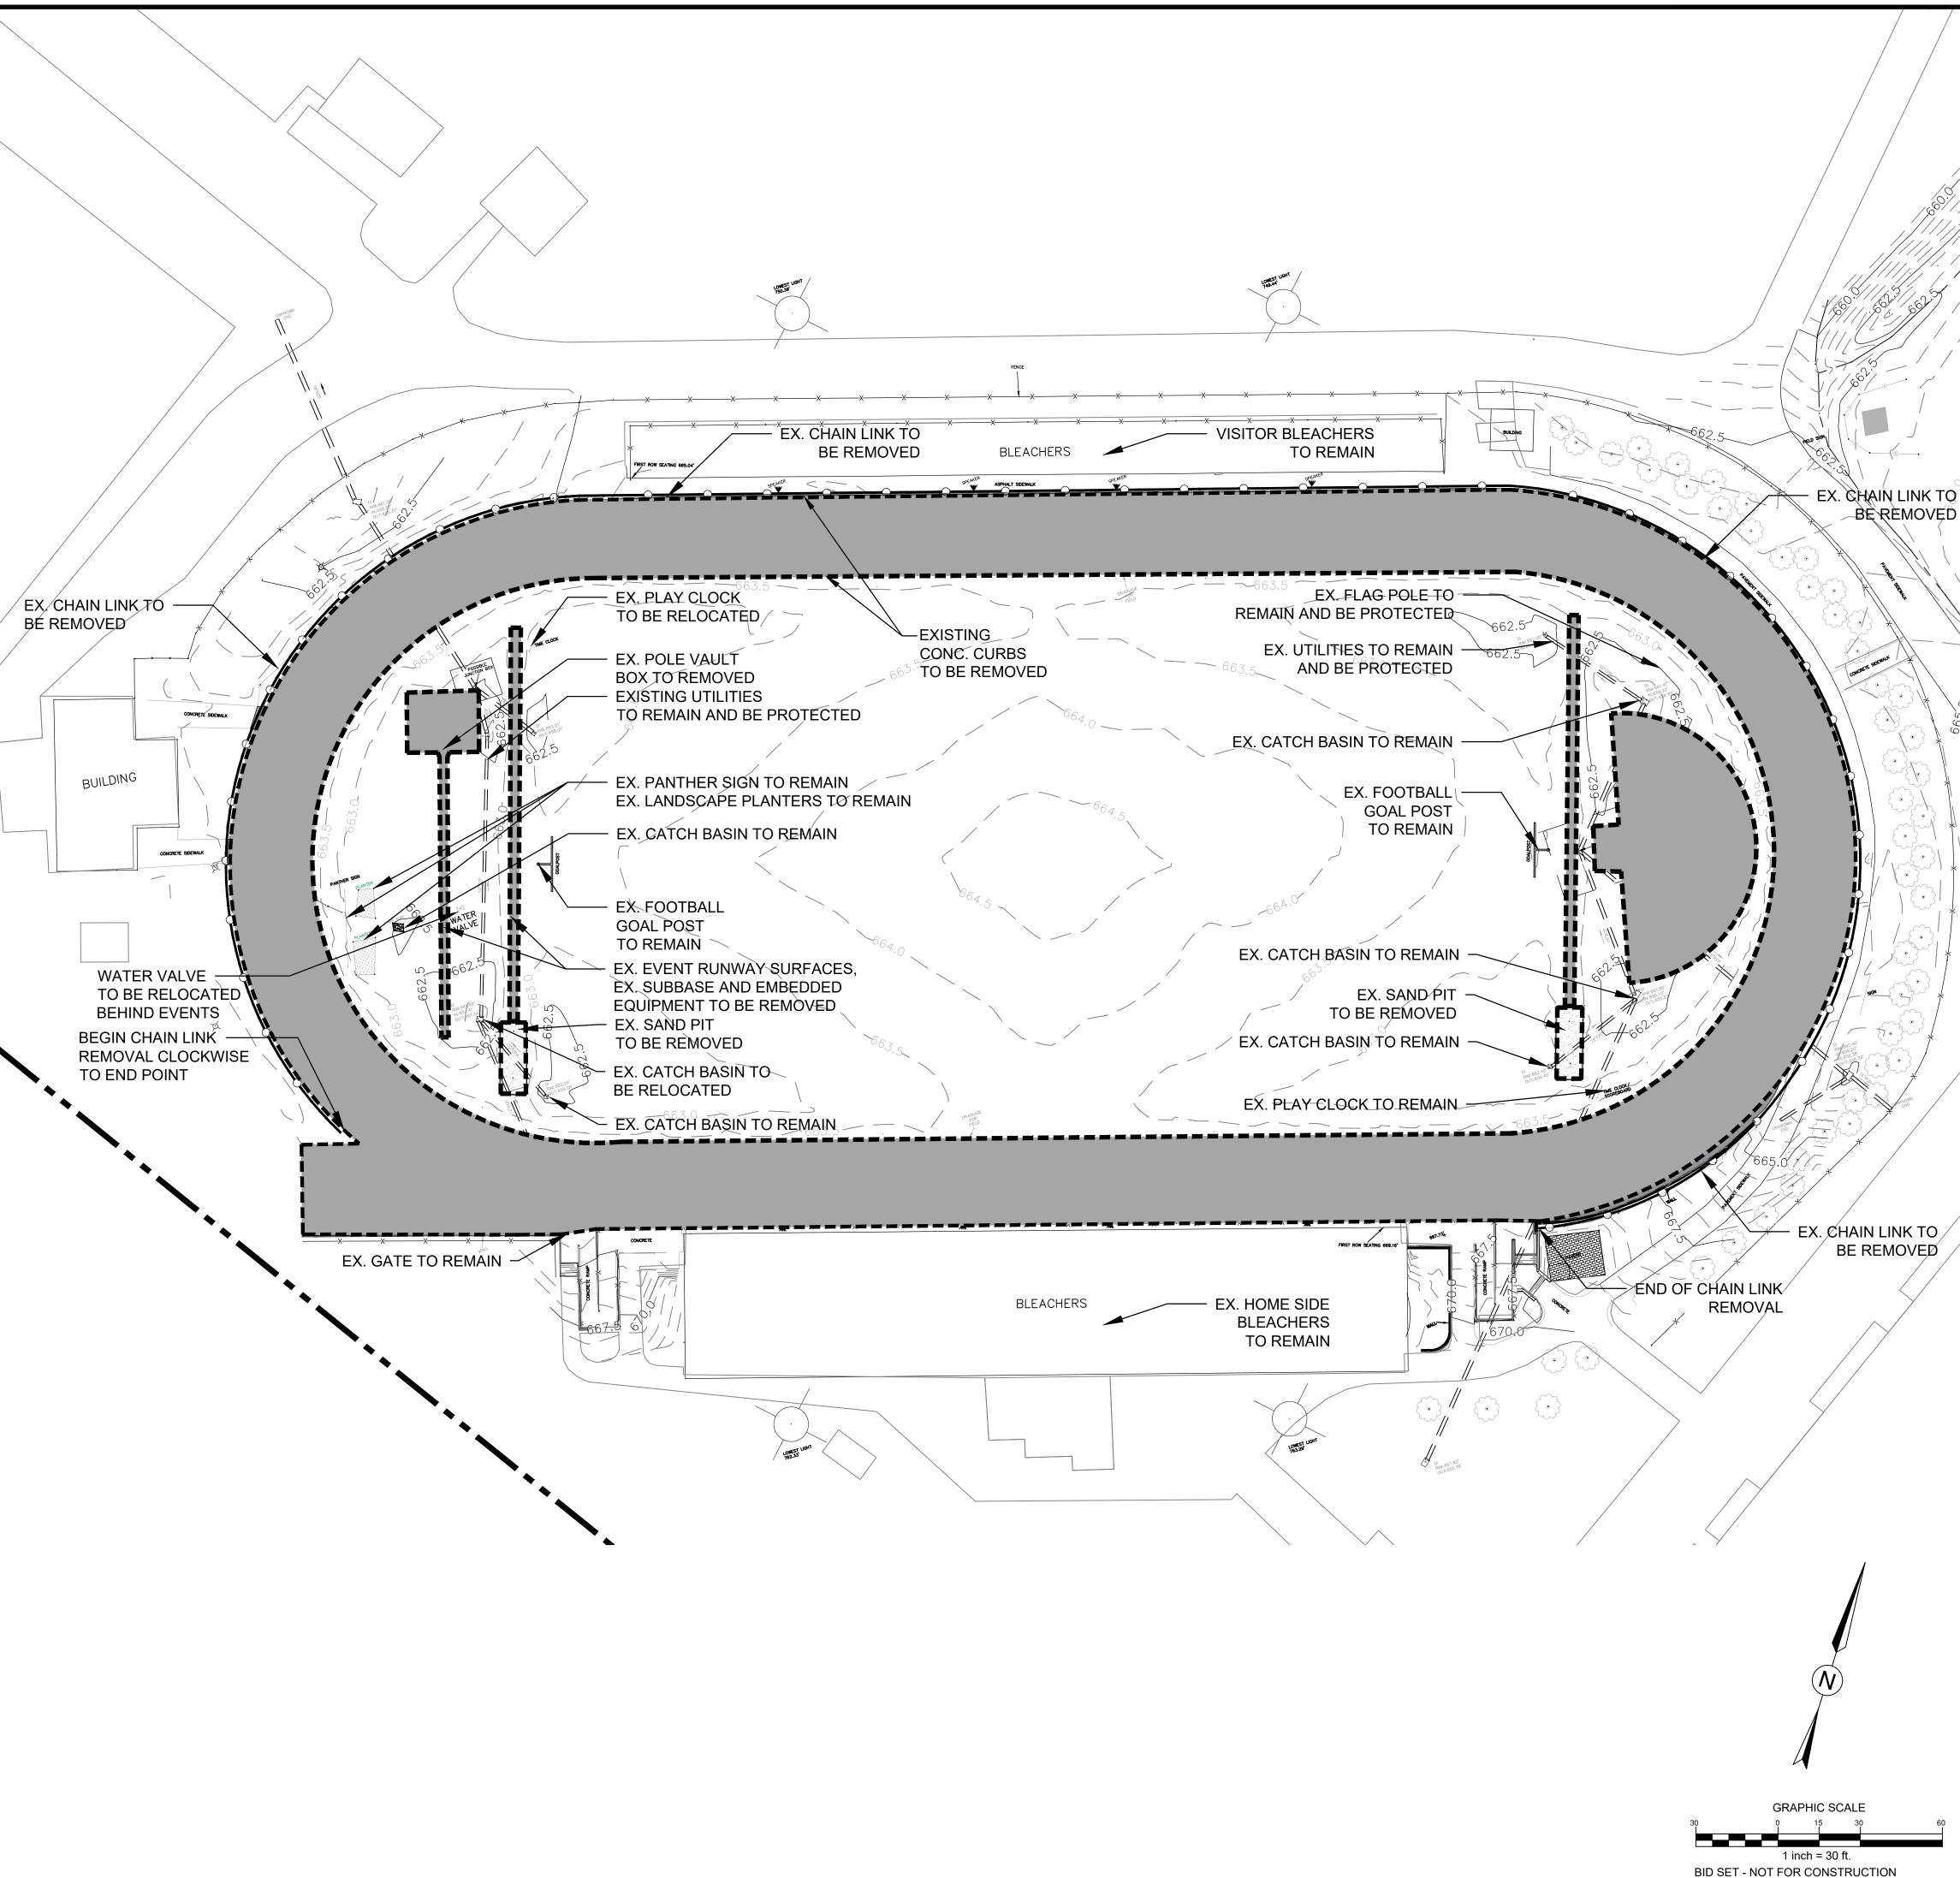
LEGEND

EXISTING STRUCTURE TO BE REMOVED.

EXISTING FENCE AND GATES TO BE REMOVED.



ONTRACTOR SHALL NOTIFY "NORTH CAROLINA ONE CALL" (811) OR 1-800-632-4949) AT LEAST 48 HOURS PRIOR TO BEGINNING CONSTRUCTION OR EXCAVATION TO HAVE EXISTING UTILITIES LOCATED. CONTRACTOR SHALL CONTACT ANY LOCAL UTILITIES THAT PROVIDE THEIR OWN LOCATOR SERVICES INDEPENDENT OF "NORTH CAROLINA ONE CALL" PORT ANY DISCREPANCIES TO THE ENGINEER IMMEDIATELY.





314 TOM HALL ST. FORT MILL, SC 803.981.4330





SCALE: 1" = 30'-0" DATE: 3-12-25

SHEET NAME: **OVAL DEMOLITION**

SHEET NO:

PLAN

DEMOLITION NOTES:

- 1. ALL PROPERTY AFFECTED BY THIS WORK SHALL BE RESTORED TO A CONDITION EQUAL TO OR BETTER THAN THE EXISTING UNLESS OTHERWISE SPECIFICALLY EXEMPTED BY THESE PLANS.
- 2. DEMOLITION DEBRIS, EXCEPT AS OTHERWISE NOTED, SHALL BECOME THE PROPERTY OF THE CONTRACTOR AND SHALL BE REMOVED FROM THE SITE. ALL DEBRIS SHALL BE DISPOSED OF OFF-SITE BY THE CONTRACTOR IN A LEGAL LANDFILL IN A TIMELY MANNER. NO SALVAGE OR SALE OF DEMOLISHED MATERIALS ON SITE WILL BE ALLOWED WITHOUT PERMISSION FROM THE OWNER
- FROM THE OWNER.

 3. REMOVE WASTE MATERIALS AND UNSUITABLE AND EXCESS TOPSOIL FROM PROPERTY AND DISPOSE OF OFF-SITE IN A LEGAL MANNER. (PERMIT REQUIRED FOR OFF-SITE DISPOSAL)
- 4. LOCATE EXISTING ABOVE GROUND AND UNDERGROUND UTILITIES IN AREAS OF WORK. IF UTILITIES ARE TO REMAIN IN PLACE, PROVIDE ADEQUATE MEANS OF SUPPORT AND PROTECTION DURING DEMOLITION OPERATION.
- 5. SHOULD UNCHARTED, OR INCORRECTLY CHARTED PIPING OR OTHER UTILITIES BE ENCOUNTERED DURING DEMOLITION, CONSULT LANDSCAPE ARCHITECT AND UTILITY OWNER FOR IMMEDIATE ACTION.
- 6. DEMOLISH AND COMPLETELY REMOVE FROM SITE MATERIAL INDICATED ON PLAN OR NOTED "TO BE REMOVED".
- 7. PROTECT STRUCTURES, UTILITIES, SIDEWALKS, PAVEMENTS, AND OTHER FACILITIES FROM DAMAGE CAUSED BY SETTLEMENT, LATERAL MOVEMENT, UNDERMINING, WASHOUT AND OTHER HAZARDS CREATED BY THE DEMOLITION OPERATION.
- 8. CONTRACTOR SHALL RESTORE ALL DISTURBED AREAS TO EXISTING CONDITIONS OR BETTER.
- 9. CONTRACTOR SHALL MAINTAIN POSITIVE STORM DRAINAGE DURING CONSTRUCTION TO INSURE NO DAMAGE TO ADJACENT PROPERTIES OCCURS DURING STORM EVENTS.
- 10. CONTRACTOR SHALL COORDINATE STORM DEMOLITION WITH STORM DRAIN IMPROVEMENTS TO MAINTAIN POSITIVE DRAINAGE.
- 11. THE CONTRACTOR IS RESPONSIBLE FOR LOCATING AND PROTECTING ALL EXISTING UTILITIES.
- 12. ALL DEMOLITION AND CONSTRUCTION SHALL COMPLY WITH APPLICABLE BUILDING CODES AND LOCAL RESTRICTIONS. THE CONTRACTOR MUST COMPLY WITH ALL OF THE CONTRACTOR REGISTRATION REQUIREMENTS OF ALL GOVERNING AUTHORITIES.
- 13. PRIOR TO THE COMMENCEMENT OF DEMOLITION, THE CONTRACTOR SHALL COORDINATE HIS ACTIVITIES WITH ALL UTILITY COMPANIES SERVING THIS AREA. THE CONTRACTOR IS TO COORDINATE FULLY WITH THE UTILITY COMPANIES ON THE EXACT LOCATION OF ALL UNDERGROUND UTILITIES PRIOR TO DEMOLITION, CONSTRUCTION, AND EXCAVATION.

 14. ALL PROPOSED PAVEMENT CUTS SHALL BE SAW CUT ONLY.
- 15. CONTRACTOR SHALL PROVIDE A MINIMUM OF 72 HOURS
 ADVANCE NOTICE TO THE OWNER PRIOR TO STARTING
 DEMOLITION ACTIVITIES.
- 16. CONTRACTOR SHALL VERIFY AND PROTECT ALL PUBLIC UTILITIES. ANY WORK ASSOCIATED WITH SAID UTILITIES TO BE COORDINATED WITH APPROPRIATE UTILITY COMPANY. DEMOLITION OF UTILITIES WHICH ARE ACTIVE SHALL BE SEQUENCED TO ALLOW FOR INSTALLATION OF NEW OR REROUTED LINES, PRIOR TO REMOVAL OF EXISTING PORTION.
- 17. THE CONTRACTOR SHALL IMMEDIATELY REPORT TO THE OWNER AND LANDSCAPE ARCHITECT ANY DISCREPANCIES FOUND BETWEEN ACTUAL FIELD CONDITIONS AND CONSTRUCTION DOCUMENTS AND SHALL WAIT FOR INSTRUCTIONS PRIOR TO PROCEEDING.
- 18.PRIOR TO BEGINNING CONSTRUCTION THE CONTRACTOR IS RESPONSIBLE TO VERIFY THAT ALL REQUIRED PERMITS AND APPROVALS HAVE BEEN OBTAINED FROM ALL REGULATORY AUTHORITIES AND SHALL BE THOROUGHLY FAMILIAR WITH CONDITIONS OF SAID PERMITS AND INSPECTION REQUIREMENTS.
- 19. THE CONTRACTOR SHALL CONTACT ALL OWNERS OF EASEMENTS, UTILITIES AND RIGHT-OF-WAYS, PUBLIC OR PRIVATE, PRIOR TO WORKING IN THESE AREAS.
- 20.THE CONTRACTOR SHALL BE RESPONSIBLE FOR DAMAGE TO ANY EXISTING ITEM AND/OR MATERIAL INSIDE OR OUTSIDE THE CONSTRUCTION LIMITS.
- 21.CONTRACTOR SHALL MAINTAIN THE SITE IN A MANNER SO THAT WORKMEN AND PUBLIC ARE PROTECTED FROM INJURY. 22.LANDSCAPE ARCHITECT SHALL NOT BE IN CONTROL OR
- CHARGE OF, AND SHALL NOT BE RESPONSIBLE FOR ACTUAL CONSTRUCTION MEANS, METHODS, TECHNIQUES, PROCEDURES, OR SAFETY PRECAUTIONS IN CONNECTION WITH THE WORK, OR FOR THE ACTS OR OMISSIONS OF CONTRACTORS OR ANY OTHER PERSONS NOT UNDER THE EMPLOYMENT OF LANDSCAPE ARCHITECT.
- 23.SHOULD THE CONTRACTOR ENCOUNTER ANY ADDITIONAL ITEMS THAT MAY REQUIRE DEMOLITION (FENCES, GUARD RAIL, ETC.) THE CONTRACTOR SHALL CONTACT THE LANDSCAPE ARCHITECT FOR FURTHER DIRECTION.

LEGEND



EXISTING TRACK SURFACE TO BE REMOVED. EXISTING BASE CAN BE REUSED WHERE APPLICABLE.



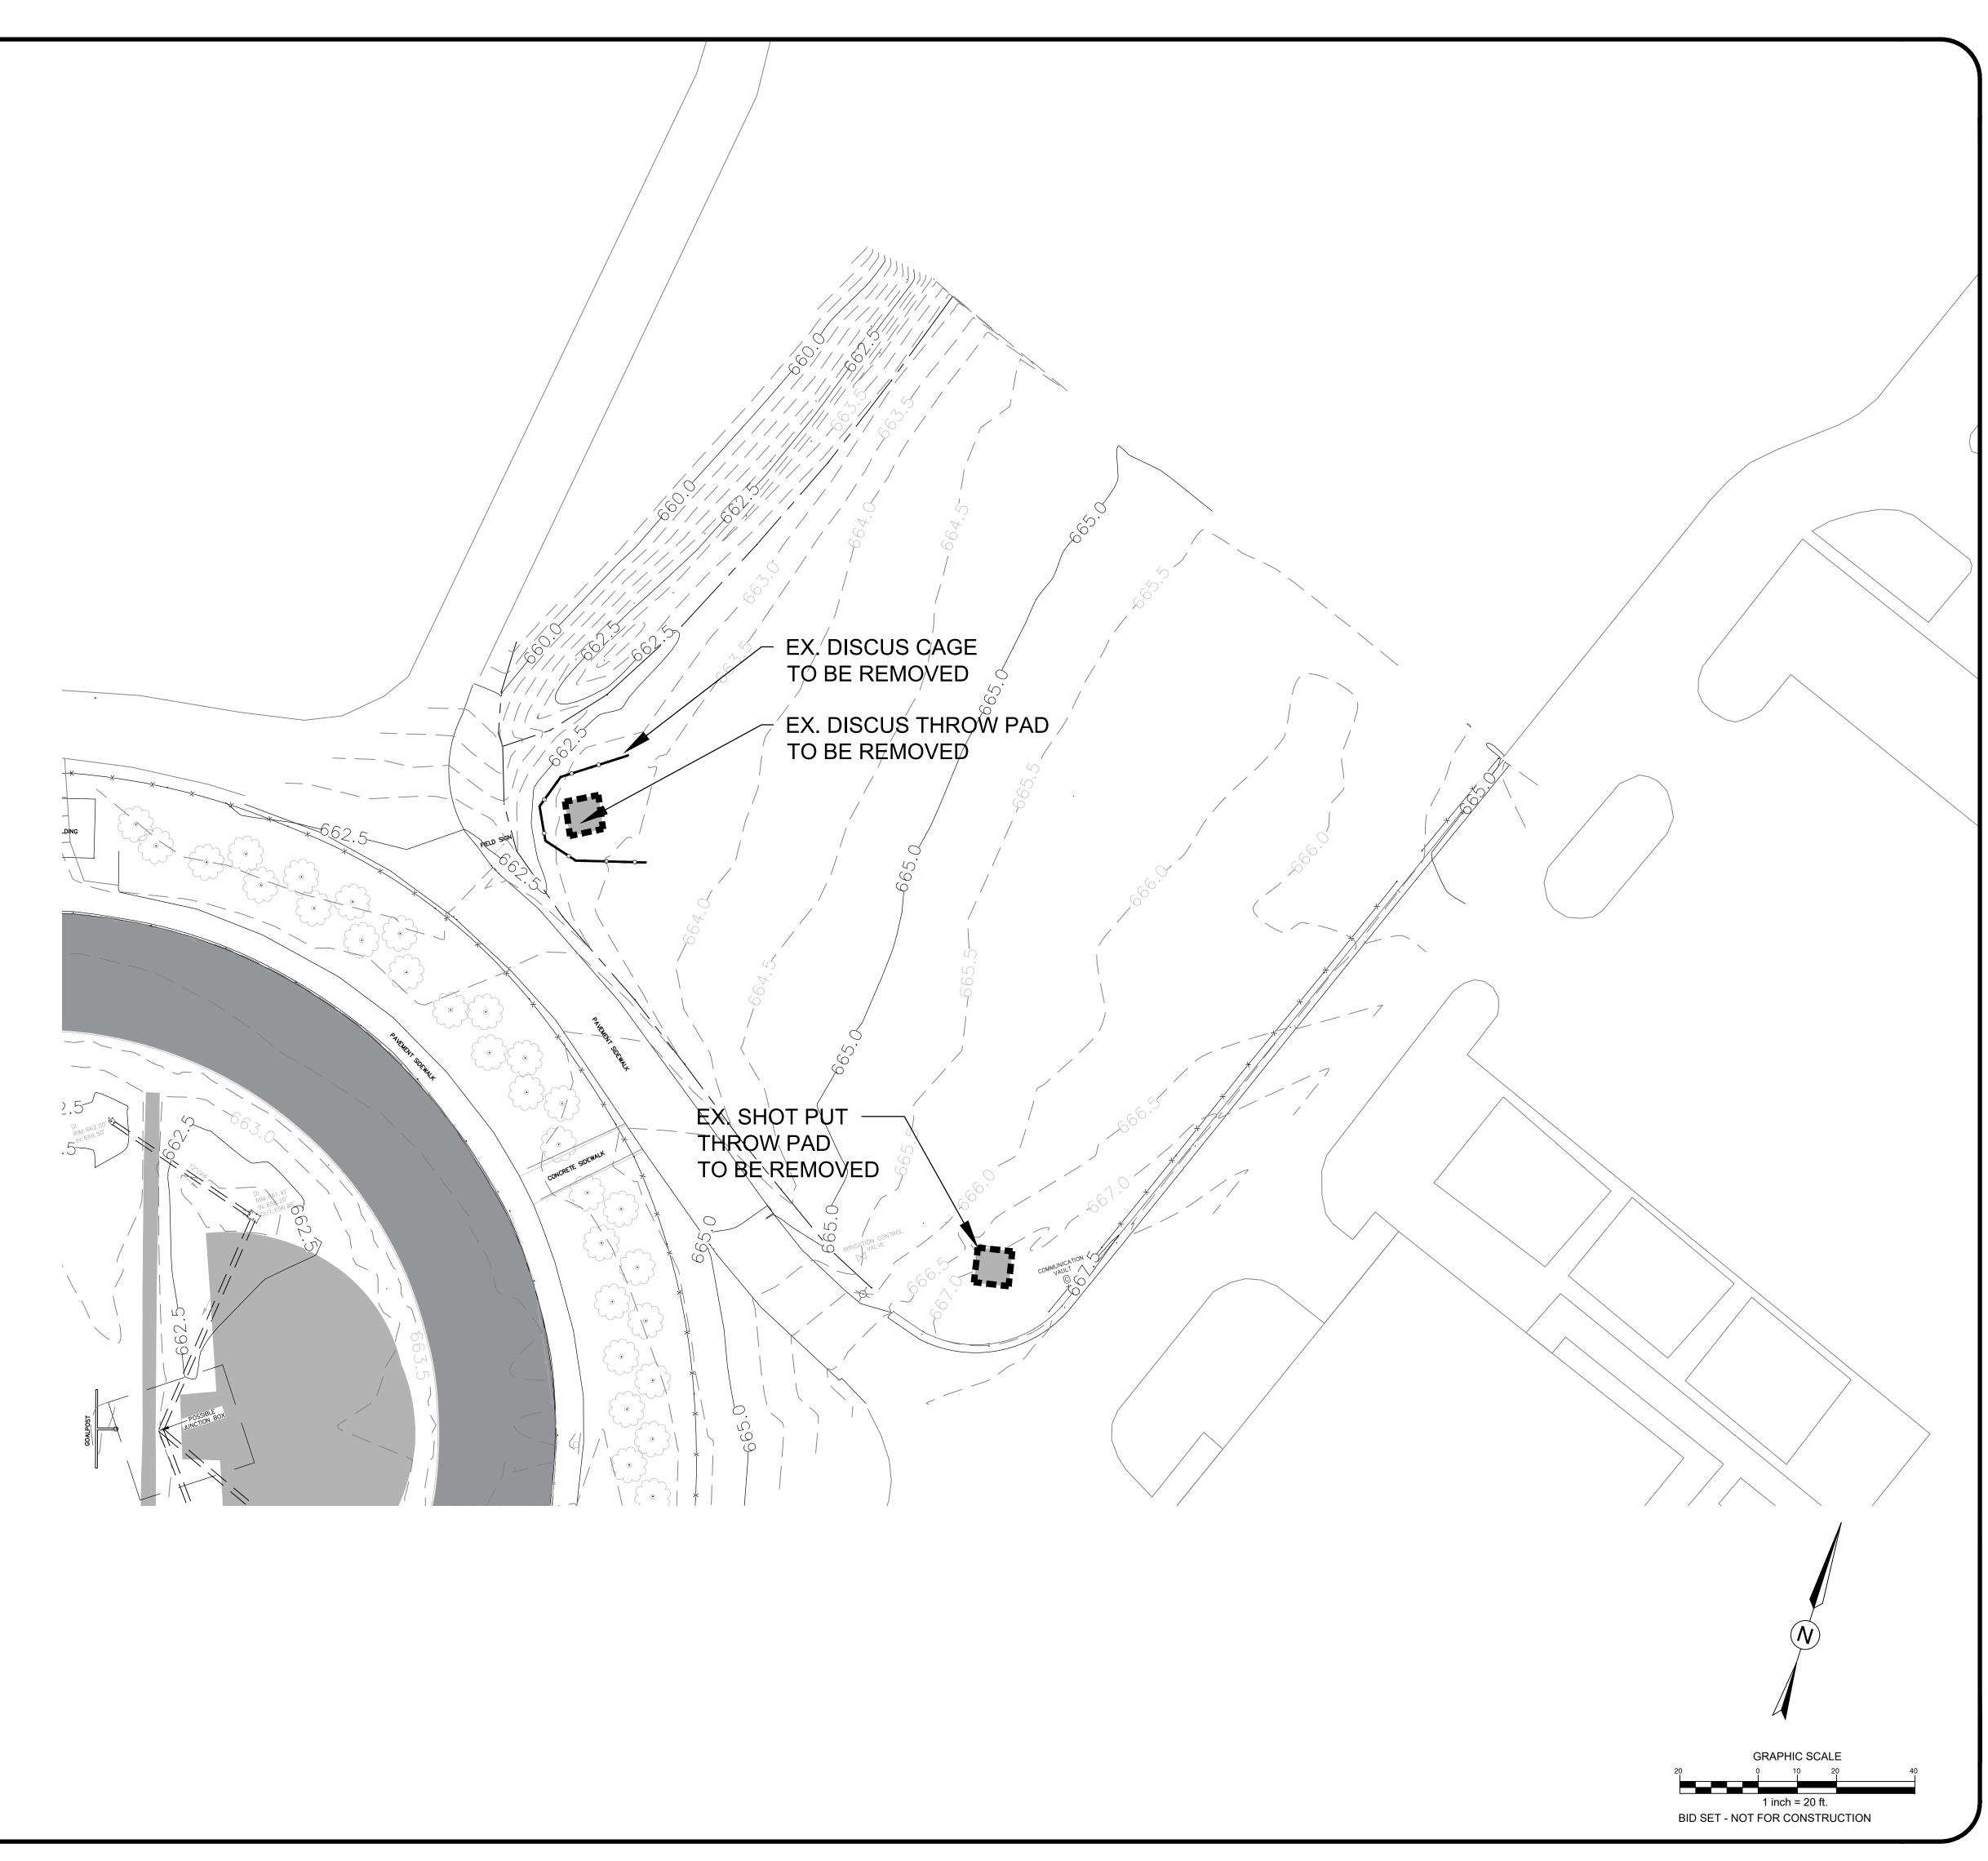
EXISTING CONCRETE CURB TO BE REMOVED.

EXISTING FENCE AND GATES TO BE REMOVED.



CONTRACTOR SHALL NOTIFY "NORTH CAROLINA ONE CALL" (811) OR (1-800-632-4949) AT LEAST 48 HOURS PRIOR TO BEGINNING CONSTRUCTION OR EXCAVATION TO HAVE EXISTING UTILITIES LOCATED.
CONTRACTOR SHALL CONTACT ANY LOCAL UTILITIES THAT PROVIDE THEIR OWN LOCATOR SERVICES INDEPENDENT OF "NORTH CAROLINA ONE CALL".

EPORT ANY DISCREPANCIES TO THE ENGINEER IMMEDIATELY.

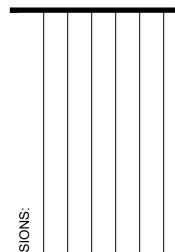




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OFFICE BOX 30035
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CHARLOTTE M
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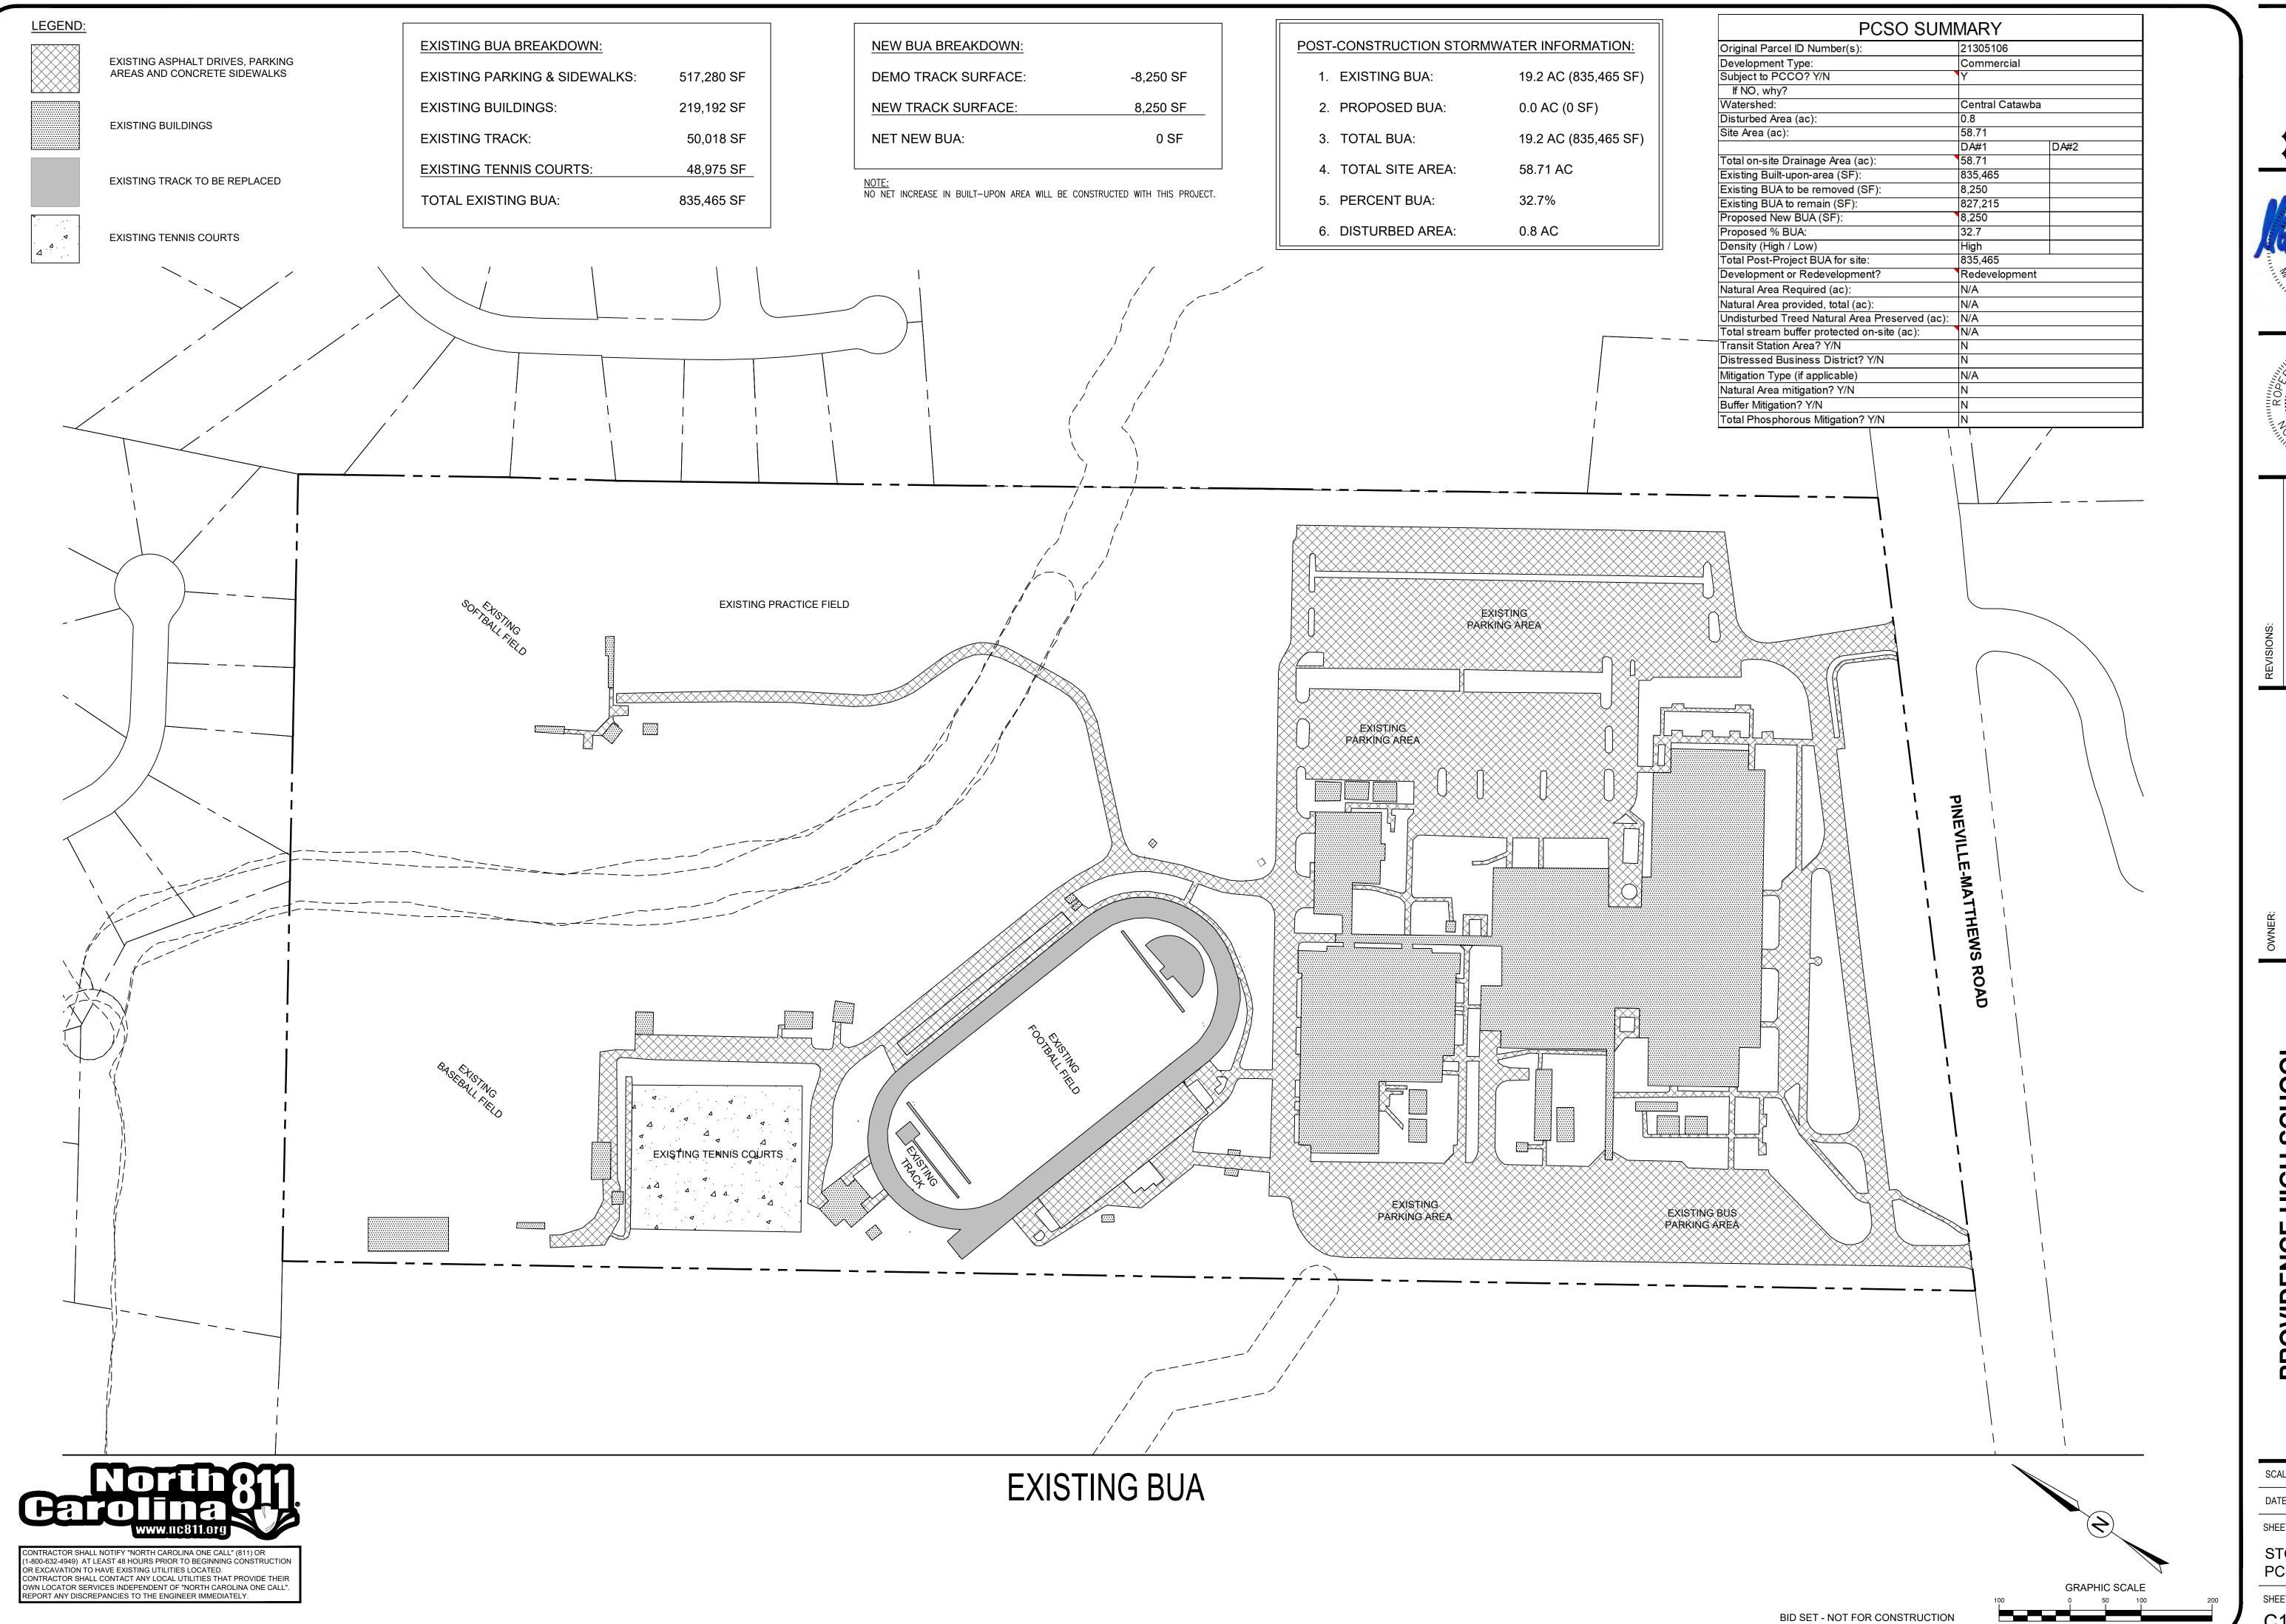
DENCE HIGH SCHOOL
CK RENOVATIONS
PINEVILLE-MATTHEWS ROAD

SCALE: 1" = 20'-0"

DATE: 3-12-25

SHEET NAME:

THROWING EVENTS
DEMOLITION PLAN



ROPER CIVIL SING Street

Soo7 Hinsdale Street

Charlotte NC 28210

3007 Hinsdale Stree Charlotte, NC 28210 (T) 704.582.3751

SEAL 24914

WGINEE WG.

CORPORATE SEAL P-1266
P-1266

REVISIONS:

TTE MECKLENBURG

D OF EDUCATION
ST OFFICE BOX 30035
ABLOTTE, NC 28230

OWNER:

CHARLOTTE MECH

BOARD OF EDU

NCE HIGH SCHOOL
K RENOVATIONS

IEVILLE-MATTHEWS ROAD

SCALE: 1" = 100'-0"

DATE: 3-12-25

SHEET NAME:

STORMWATER PCSO PLAN

SHEET NO: **C104**

EROSION CONTROL NOTES:

- 1. THIS EROSION CONTROL PLAN SHALL BE IMPLEMENTED IN ACCORDANCE WITH THE STANDARDS OF THE CITY OF CHARLOTTE, MECKLENBURG COUNTY, AND/OR NCDEQ AS APPLICABLE. ALL EROSION CONTROL MEASURES SHALL BE CONSTRUCTED IN ACCORDANCE WITH THE NC EROSION AND SEDIMENT CONTROL PLANNING AND DESIGN MANUAL, U.S. DEPARTMENT OF AGRICULTURE, CITY OF CHARLOTTE EROSION CONTROL ORDINANCE, AND THE LAND DEVELOPMENT STANDARDS MANUAL.
- 2. ADDITIONAL MEASURES TO CONTROL EROSION AND SEDIMENT MAY BE REQUIRED BY THE INSPECTOR.
- SILT FENCE NOTES:
- A. HIGH HAZARD SILT FENCE SHALL BE USED AT ALL LOCATIONS WHERE CONSTRUCTION
- ACTIVITIES ARE WITHIN 30' OF THE TOP OF CREEK BANKS OR EXISTING PONDS. B. REGULAR SILT FENCE SHALL BE USED AT ALL OTHER LOCATIONS, EXCEPT AS DIRECTED BY THE INSPECTOR. AS A RULE, SILT FENCE SHALL BE PROVIDED AT THE DOWN-GRADE PERIMETER OF DISTURBED AREAS. THE FINAL LOCATION OF SILT FENCE MAY BE FILED ADJUSTED AS REQUIRED PER SITE CONDITIONS, AND/OR AS DIRECTED BY THE INSPECTOR.
- C. SILT FENCE OUTLETS SHALL BE PLACED AT NATURAL LOW POINTS.
- 4. IN AREAS WHERE SILT FENCE IS NOT REQUIRED, BUT THE CONTRACTOR DESIRES TO RESTRICT ACCESS, ORANGE TREE PROTECTION/BARRIER FENCE MAY BE UTILIZED.
- 5. A TEMPORARY CONSTRUCTION ENTRANCE WILL BE CONSTRUCTED ADJACENT TO THE TRACK TO MINIMIZE TRACKING OF SEDIMENT ONTO THE PARKING AREAS AND ADJACENT
- ROCK CHECK DAMS OR WATTLES SHALL BE PLACED AT LOW POINTS IN NATURAL DRAINAGE PATTERNS TO CONTROL VELOCITY AND MINIMIZE THE LOSS OF SEDIMENT.
- 7. FOR ANY AREAS WHERE MATERIAL SUBJECT TO EROSION IS BEING STOCKPILED (TOPSOIL STRIPPINGS, ETC), TEMPORARY EROSION CONTROL MEASURES MAY BE NECESSARY AT THE STOCKPILE PERIMETER IN ORDER TO MINIMIZE THE SEDIMENT LOSS.
- 8. STABILIZATION IS THE BEST FORM OF EROSION CONTROL. TEMPORARY SEEDING IS NECESSARY TO ACHIEVE EROSION CONTROL ON LARGE DENUDED AREAS AND ESPECIALLY WHEN SPECIFICALLY REQUIRED AS PART OF THE CONSTRUCTION SEQUENCE. ALL SLOPES MUST BE SEEDED AND MULCHED WITHIN 7 DAYS. REFER TO EROSION CONTROL ORDINANCE FOR ADDITIONAL REQUIREMENTS.
- 9. ALL EROSION CONTROL DEVICES SHALL BE INSPECTED AT LEAST ONCE PER WEEK AND AFTER EACH STORM EVENT OF 0.5" OR MORE. IF ANY FAILURES ARE FOUND THEY SHOULD BE REPAIRED AS SOON AS POSSIBLE.
- 10. EFFECTIVE OCTOBER 1, 2010, PERSONS RESPONSIBLE FOR LAND DISTURBING ACTIVITIES MUST INSPECT A PROJECT AFTER EACH PHASE OF THE PROJECT TO MAKE SURE THAT THE APPROVED EROSION AND SEDIMENTATION CONTROL PLAN IS BEING FOLLOWED. SELF- INSPECTION REPORTS ARE REQUIRED. A SAMPLE SELF INSPECTION, AS WELL AS DETAILS OF THE SELF-INSPECTION PROGRAM, CAN BE FOUND ON THE NCDEQ
- 11. ANY SEDIMENT OR MATERIAL TRACKED ONTO THE ADJACENT STREETS SHALL BE SWEPT AND REMOVED IMMEDIATELY.
- 12. ALL DISTURBED AREAS WILL BE PROVIDED WITH PERMANENT GROUNDCOVER.

CHARMECK EROSION CONTROL NOTES:

- ANY GRADING BEYOND THE DENUDED LIMITS SHOWN ON THE PLAN IS A VIOLATION OF THE TOWN/COUNTY EROSION CONTROL ORDINANCE AND IS SUBJECT TO A FINE.
- GRADING MORE THAN ONE-ACRE WITHOUT AN APPROVED EROSION CONTROL PLAN IS A VIOLATION OF THE TOWN/COUNTY EROSION CONTROL ORDINANCE AND IS SUBJECT TO A
- ADDITIONAL MEASURES TO CONTROL EROSION AND SEDIMENT MAY BE REQUIRED BY A REPRESENTATIVE OF THE TOWN/COUNTY ENGINEERING DEPARTMENT.
- APPROVAL OF THIS PLAN IS NOT AN AUTHORIZATION TO GRADE ADJACENT PROPERTIES. WHEN FIELD CONDITIONS WARRANT OFF-SITE GRADING, PERMISSION MUST BE OBTAINED FROM THE AFFECTED PROPERTY OWNERS.

MAINTENANCE SCHEDULE:

- 1) ALL EROSION AND SEDIMENT CONTROL PRACTICES SHALL BE CHECKED FOR STABILITY AND OPERATION FOLLOWING EVERY STORM EVENT, BUT IN NO CASE LESS THAN ONCE EVERY WEEK. ANY REPAIRS OR CLEANING NECESSARY TO MAINTAIN EROSION AND SEDIMENT CONTROL PRACTICES SHALL BE COMPLETED IMMEDIATELY.
- 2) ALL SEEDED AREAS SHALL BE REFERTILIZED, RESEEDED AS NECESSARY, AND MULCHED ACCORDING TO THE SEEDING SCHEDULE.

UTILITY NOTES:

1) ALL EXISTING UTILITIES TO BE ABANDONED SHOULD BE GROUTED; ADDITIONALLY ALL ABANDONED PIPES SHOULD BE CHECKED WITH FOOTING DEPTHS AND PROPOSED UTILITIES, AND REMOVED IF CONFLICT OCCURS.

CONSTRUCTION SEQUENCE (PHASE 1):

- 1. OBTAIN GRADING/EROSION CONTROL PLAN APPROVAL FROM NCDEQ DEMLR , CITY OF CHARLOTTE STORMWATER, AND ALL OTHER NECESSARY PERMITS FROM OTHER APPLICABLE AGENCIES.
- 2. AFTER APPROVAL FROM CITY OF CHARLOTTE STORMWATER, FILE THE ELECTRIC NOTICE OF INTENT (ENOI) ONLINE TO OBTAIN AN EROSION AND SEDIMENT CONTROL (E&SC) PERMIT AND A CERTIFICATE OF COVERAGE (COC) FROM NCDEQ BEFORE ANY LAND DISTURBING ACTIVITIES CAN OCCUR.
- 3. AT LEAST 48 HOURS PRIOR TO BEGINNING CONSTRUCTION, CONTACT THE DEMLR SECTION IN THE MOORESVILLE REGIONAL DEQ OFFICE AT (704)663-1699, CITY OF CHARLOTTE INSPECTORS, AND THE ENGINEER. MEET WITH DEMLR REPRESENTATIVES AND THE ENGINEER ON-SITE AT THEIR REQUEST FOR A PRE-CONSTRUCTION MEETING.
- 4. PER NPDES REQUIREMENTS, A RAIN GAUGE, SELF-INSPECTIONS RECORDS, PERMIT, CERTIFICATE OF COVERAGE, AND SEDIMENT AND EROSION CONTROL PLAN ARE REQUIRED TO BE MAINTAINED ON SITE AND ACCESSIBLE DURING INSPECTION. IT IS RECOMMENDED THAT THESE ITEMS BE PLACED IN A PERMITS BOX AT THE BEGINNING OR
- 5. INSTALL EROSION CONTROL MEASURES PER THE APPROVED PLAN OR AS DIRECTED BY
- 6. CALL FOR ON-SITE INSPECTION OF INSTALLED MEASURES BY THE INSPECTOR. AFTER APPROVAL BY THE INSPECTOR, CONSTRUCTION MAY BEGIN.
- 7. SELF-INSPECTIONS FOR EROSION AND SEDIMENTATION CONTROL MEASURES ARE TO BE PERFORMED AT LEAST ONCE EVERY SEVEN CALENDAR DAYS AND WITHIN 24 HOURS OF EVERY RAIN EVENT OF GREATER THAN 1-INCH. ANY NEEDED REPAIRS SHALL BE MADE IMMEDIATELY TO MAINTAIN MEASURES AS DESIGNED. ALL E&SC MEASURES SHALL BE MAINTAINED AS SPECIFIED IN THE CONSTRUCTION DETAILS ON THIS PLAN. A RAIN GAUGE SHALL BE INSTALLED AT THE PROJECT SITE FOR MONITORING.
- 8. DEMOLISH AND REMOVE THE EXISTING TRACK SURFACE AND SUBGRADE, EXISTING TRACK FEATURES (LONG JUMP. HIGH JUMP. ETC). EXISTING STORM PIPE AND STRUCTURES, AND ANY OTHER ITEMS SHOWN ON THE DEMO PLAN. STRIP AND REMOVE EXISTING GRASS, ROOT MAT, AND TOPSOIL FROM LAWN AREAS OF THE SITE. THIS MATERIAL SHALL BE STORED IN THE APPROVED STOCKPILE LOCATION. ANY MATERIAL REMOVED FROM THE SITE SHALL BE DISPOSED OF IN AN NCDEQ PERMITTED EROSION CONTROL SITE.
- 9. EXCAVATE TO THE PROPOSED SUBGRADE ELEVATION IN THE LIMITS OF THE PROPOSED TRACK REPLACEMENT.
- 10. STRIP AND REMOVE EXISTING GRASS, ROOT MAT, AND TOPSOIL FROM THE D-AREAS OF THE TRACK IN THE HIGH JUMP AREA. THIS MATERIAL SHALL BE STORED IN THE APPROVED STOCKPILE LOCATION.
- 11. SILT BAGS SHALL BE UTILIZED AS NECESSARY IN THE AREAS SHOWN ON THE PLAN AND SHALL BE CONTINUOUSLY MONITORED DURING OPERATION.
- 12. PRIOR TO PLACEMENT / COMPACTION OF ANY BACK FILL WITHIN THESE AREAS, THE ON-SITE GEOTECHNICAL ENGINEER SHALL INSPECT THE SUB-GRADE. IF THE CONTRACTOR CONSTRUCTS AND COVERS UP THESE AREAS PRIOR TO INSPECTION, THEN THE SUB-GRADE SHALL BE UNCOVERED AND TESTED AT THE CONTRACTOR'S EXPENSE. NO BACKFILL MATERIAL SHALL BE PLACED FOR THE TRACK AREA UNTIL APPROVAL IS OBTAINED FROM THE ON-SITE GEOTECHNICAL ENGINEER.
- 13. REMOVE THE EXISTING DRAINAGE PIPE TIE-INS FROM THE TRACK TRENCH DRAIN AS SHOWN ON THE DEMOLITION AND DRAINAGE PLAN.
- 14. INSTALL THE NEW DRAINAGE TIE-INS TO THE PROPOSED TRACK TRENCH DRAIN IN THE LOCATIONS SHOWN ON THE DRAINAGE PLAN.
- 15. ONCE THE DRAINAGE HAS BEEN INSTALLED, PROCEED TO PHASE 2 OF THE EROSION CONTROL PLANS.

- THE PURPOSE OF THIS PLAN IS TO DEFINE THE EROSION CONTROL REQUIREMENTS RELATED TO THE TRACK REPLACEMENT AT PROVIDENCE HIGH SCHOOL.
- 1. SITE BOUNDARIES, BUILT-UPON AREA, AND PCSO BUFFERS FOR THE HIGH SCHOOL CAMPUS AREA OBTAINED FROM MECKLENBURG COUNTY GIS DATA. FIELD LOCATION SURVEYS HAVE BEEN PERFORMED OF THE TRACK AND FIELD PROJECT AREAS ONLY
- 2. DUE TO A LAND DISTURBANCE OF GREATER THAN ONE-ACRE. THIS PROJECT IS SUBJECT TO THE CITY OF CHARLOTTE POST CONSTRUCTION STORMWATER ORDINANCE REGULATIONS. PER THE CITY PCSO.THE SITE IS A REDEVELOPMENT THAT DOES NOT INCREASE BUILT UPON AREA. DUE TO THE REDEVELOPMENT STATUS OF THE SITE, LOCATED IN THE CENTRAL CATAWBA PC DISTRICT, THE PROJECT IS NOT SUBJECT TO WATER QUANTITY AND/OR WATER QUALITY REQUIREMENTS.
- 3. THE CONTRACTOR SHALL BE RESPONSIBLE FOR VERIFICATION OF ALL EXISTING UTILITY LOCATIONS PRIOR TO COMMENCEMENT OF WORK. ANY UTILITY SHOWN ON THIS PLAN IS FOR REFERENCE ONLY, AND SHALL BE VERIFIED BY THE CONTRACTOR PRIOR TO THE COMMENCEMENT OF WORK. THE CONTRACTOR SHALL PROTECT ALL EXISTING UTILITIES FROM DAMAGE DURING

CONSTRUCTION SEQUENCE (PHASE 2):

- 1. ONCE THE DRAINAGE PIPE HAS BEEN RELOCATED AND TIED INTO THE EXISTING STORM DRAINAGE SYSTEM, THE CONTRACTOR MAY BEGIN INSTALLATION OF THE COMPACTED STONE SUBGRADE FOR THE TRACK REPLACEMENT.
- 2. CONTRACTOR TO BEGIN WORK ON OTHER HARDSCAPE AREAS OF THE TRACK REPLACEMENT PLAN INCLUDING SIDEWALK ACCESS, LONG JUMP RUNWAYS, POLE VAULT RUNWAYS, HIGH JUMP PAD, AND THROWING PADS.
- 3. CONTRACTOR TO INSTALL PERIMETER CURB AND PAVING SURFACE FOR TRACK AS SHOWN ON THE PLANS. CONTRACTOR TO INSTALL PERIMETER FENCE AROUND TRACK AFTER PAVING IS COMPLETE.
- 4. CONTRACTOR TO INSTALL FIELD ITEMS (LONG JUMP RUNWAYS, POLE VAULT RUNWAYS, HIGH JUMP PAD, AND THROWING PADS, ETC.) AS SHOWN ON THE PLANS.
- 5. SELF-INSPECTIONS FOR EROSION AND SEDIMENTATION CONTROL MEASURES ARE TO BE PERFORMED AT LEAST ONCE EVERY SEVEN CALENDAR DAYS AND WITHIN 24 HOURS OF EVERY RAIN EVENT OF GREATER THAN 1-INCH. ANY NEEDED REPAIRS SHALL BE MADE IMMEDIATELY TO MAINTAIN MEASURES AS DESIGNED. ALL E&SC MEASURES SHALL BE MAINTAINED AS SPECIFIED IN THE CONSTRUCTION DETAILS ON THIS PLAN. A RAIN GAUGE SHALL BE INSTALLED AT THE PROJECT SITE FOR MONITORING.
- 6. STABILIZATION IS THE BEST FORM OF EROSION CONTROL. TEMPORARY SEEDING IS NECESSARY TO ACHIEVE EROSION CONTROL ON LARGE DENUDED AREAS. ALL SLOPES MUST BE SEEDED AND MULCHED WITHIN DAYS. REFER TO EROSION CONTROL ORDINANCE FOR ADDITIONAL REQUIREMENTS.
- 7. THE CONTRACTOR SHALL DILIGENTLY AND CONTINUOUSLY MAINTAIN ALL EROSION
- 8. STABILIZE THE SITE AS AREAS ARE BROUGHT UP TO FINISHED GRADE.
- 9. AFTER FINAL SITE STABILIZATION OCCURS, COORDINATE WITH THE INSPECTOR PRIOR TO REMOVAL OF EROSION CONTROL MEASURES.
- 10. WHEN THE PROJECT IS COMPLETE, THE PERMITTEE SHALL CONTACT DEMLR TO CLOSE OUT THE E&SC PLAN. SUBMIT NOTICE OF TERMINATION (NOT) TO CITY OF CHARLOTTE AND NCDEO AS APPROPRIATE

STREAM/WETLANDS NOTES:

- JURISDICTIONAL STREAMS AND WETLANDS HAVE NOT BEEN LOCATED ON THE SITE.
- NO DISTURBANCE OF JURISDICTIONAL STREAMS OR WETLANDS ARE PROPOSED FOR THIS PROJECT

DEWATERING OPERATION:

IN AN APPROVED MANNER.

- 1. DEWATERING MAY BE NECESSARY IN THE EXCAVATION AREAS (E.G. SUBGRADE AREAS), THE CONTRACTOR SHALL FURNISH, INSTALL. OPERATE, AND MAINTAIN ANY PUMPING EQUIPMENT, ETC. NEEDED FOR REMOVAL OF WATER FROM VARIOUS PARTS OF THE SITE.
- 2. DURING PLACEMENT OF FILL WITHIN THESE AREAS, THE CONTRACTOR SHALL KEEP THE WATER LEVEL BELOW THE BOTTOM OF THE EXCAVATION / CONSTRUCTION AREAS. THE MANNER IN WHICH THE WATER IS REMOVED SHALL BE SUCH THAT THE EXCAVATION BOTTOM AND SIDE SLOPES ARE STABLE, WITH NO SEDIMENT DISCHARGED FROM THE SITE (I.E. PUMPED WATER MAY NEED TO BE DIRECTED TO AN APPROVED EROSION CONTROL DEVICE PRIOR TO DISCHARGE)
- 3. DEWATERING OPERATION MAY NOT OCCUR DURING PERIODS OF HEAVY PRECIPITATION
- 4. PUMPS MUST DISCHARGE INTO FILTER BAGS THAT DISCHARGE INTO A WELL VEGETATED AREA.
- 5. PUMPS MUST NOT DISCHARGE INTO STORM DRAINS OR WATERWAYS AND MUST BE A MINIMUM OF 50-FEET FROM STORM INLETS.
- 6. ACCUMULATED SEDIMENT FROM FILTER BAGS MUST BE DISPOSED OF
- 7. SEE SEDIMENT FILTER BAG DETAIL ON SHEET C202 FOR ADDITIONAL INFORMATION.

COUNTY STANDARD EROSION CONTROL NOTES:

- 1. ALL "STD" NUMBERS REFER TO MECKLENBURG COUNTY LAND DEVELOPMENT STANDARDS MANUAL (MCLDS).
- 2. ON-SITE BURIAL PITS REQUIRE AN ON-SITE DEMOLITION LANDFILL PERMIT FROM THE ZONING ADMINISTRATOR.
- 3. ANY GRADING BEYOND THE DENUDED LIMITS SHOWN ON THE PLAN IS A VIOLATION OF
- THE COUNTY EROSION CONTROL ORDINANCE AND IS SUBJECT TO A FINE. 4. GRADING MORE THAN ONE-ACRE WITHOUT AN APPROVED EROSION CONTROL PLAN IS A
- 5. ALL PERIMETER AREAS AND SLOPES GREATER THAN 3:1 SHALL BE STABILIZED WITHIN 7 DAYS. GROUND STABILIZATION ON ALL OTHER AREAS MUST BE COMPLETED WITHIN 14

VIOLATION OF THE COUNTY EROSION CONTROL ORDINANCE AND IS SUBJECT TO A FINE.

DAYS. REFER TO THE EROSION CONTROL ORDINANCE FOR ADDITIONAL REQUIREMENTS.

- 6. ADDITIONAL MEASURES TO CONTROL EROSION AND SEDIMENT MAY BE REQUIRED BY A REPRESENTATIVE OF THE COUNTY.
- 7. A GRADING PLAN MUST BE SUBMITTED FOR ANY LOT GRADING EXCEEDING ONE ACRE THAT WAS NOT PREVIOUSLY APPROVED.
- 8. TEMPORARY DRIVEWAY PERMIT FOR CONSTRUCTION ENTRANCES IN NCDOT RIGHT-OF-WAY MUST BE PRESENTED AT PRE-CONSTRUCTION MEETING.
- 9. ALL EMBANKMENTS MUST BE CONSTRUCTED PER SECTION 4.0.6 EMBANKMENT REQUIREMENTS IN THE BMP DESIGN MANUAL.
- 10. SLOPES SHALL BE GRADED NO STEEPER THAN 2:1. SLOPED GREATER THAN 10 VERTICAL FEET REQUIRE ADEQUATE TERRACING (MCLDSM #30.16). SOILS ENGINEER TO VERIFY STABILITY OF SLOPES GREATER THAN 2:1.
- 11. SOIL COMPACTION TESTS ARE REQUIRED ON ANY BERM >=5' IN HEIGHT FROM THE NATURAL GRADE. SOIL COMPACTION MUST BE AT 95% PROCTOR AND CERTIFIED BY A LICENSED SOIL ENGINEER.

SWIM/PCO BUFFER NOTES:

- 1. BUFFER WIDTHS ARE SHOWN AND LABELED ON PLANS AND ARE CORRECT BASED ON
- 2. PLANS INDICATE THAT ALL ENGINEERED CHANNELS. PIPED OUTFALLS, AND RIPRAP APRONS END OUTSIDE OF THE BUFFER.
- 3. DRAINAGE OUTFALLS MUST BE DESIGNED TO ALLOW WATER TO SHEET FLOW ACROSS THE BUFFER TO FILTER OUT POLLUTANTS.
- 4. ENERGY DISSIPATORS, DIVERSION DEVICES OR WETLAND FLOW MUST BE USED TO SPREAD CONCENTRATED FLOWS AND MUST BE LOCATED OUTSIDE THE BUFFER AREA. ADEQUATE VEGETATIVE COVER MUST BE RETAINED OR RE-ESTABLISHED BELOW ENERGY DISSIPATORS TO PREVENT EROSION.
- 5. NO OUTLET DRAINS MORE THAN 10 ACRES DRAINAGE AREA TO ANY ONE POINT IS A STREAM BUFFER.
- 6. WHERE DISTURBANCE TO THE BUFFER IS SHOWN, A LETTER FROM WATER QUALITY IS REQUIRED STATING THAT THE DISTURBANCE SHOWN IS ALLOWABLE OR WHETHER A MITIGATION PLAN HAS BEEN APPROVED.
- 7. ALL TEMPORARY SEDIMENT BASINS AND ALL OTHER EROSION DEVICES ARE LOCATED OUTSIDE OF THE MINIMUM BUFFER WIDTH.

8. BUFFER DELINEATION:

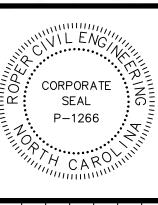
- BUFFER AREA IS CLEARLY IDENTIFIED ON PLANS IN BOLD, CLEAR TYPE AS "SWIM/PCO
- THE OUTSIDE BOUNDARY OF EACH BUFFER ZONE IS CLEARLY MARKED AND LABELED ON PLANS (STREAM SIDE, MANAGED USE, UPLAND).
- FIELD LOCATED TOP OF BANK FROM WHERE THE BUFFER WIDTH IS MEASURED AND LABELED ON PLANS. - STREAMS AND BUFFER BOUNDARIES INCLUDING THE DELINEATION OF EACH ZONE
- AND A DIMENSION FROM A SPECIFIC LOCATION ARE SHOWN ON ALL SURVEYS AND RECORD PLATS, INCLUDING INDIVIDUAL RECORD PLATS FOR ANY LOTS AFFECTED. - WHERE APPLICABLE FOR 100' BUFFERS/50% ADDITIONAL WIDTH: PROVIDE CALCULATIONS FOR 50% ADDITIONAL WIDTH BASED ON THE AREA BETWEEN THE CURRENT 100-YEAR FEMA FRINGE BOUNDARY TO THE 100' SWIM BUFFER OR THE 0.1 FLUM ENCROACHMENT LINE, WHICHEVER IS LESS.
- 9. THE STREAMSIDE ZONE OF THE BUFFER MUST BE LEFT COMPLETELY UNDISTURBED. IN THE MANAGED USE ZONE, A LIMITED NUMBER OF TREES CAN BE REMOVED PROVIDED THAT THE TREE DENSITY REMAINING IS A MINIMUM OF 8 HEALTHY TREES OF A MINIMUM 6-INCH CALIPER PER 1,000 SQUARE FEET. REMOVAL OF EXISTING VEGETATION MUST BE PERFORMED IN SUCH A MANNER AS TO PREVENT DAMAGE TO THE ROOTS OF THE REMAINING TREES.
- 10. PLANS CLEARLY INDICATE THAT NO FILL MATERIAL IS TO BE BROUGHT INTO THE BUFFER AND THAT NO STRUCTURES ARE ALLOWED WITHIN ANY BUFFER AREAS (EXCEPT NON-COMMERCIAL OUT BUILDINGS NOT EXCEEDING 150 SQUARE FEET).
- 11. GRADING AND OTHER LAND-DISTURBING ACTIVITES ARE ALLOWED ONLY IN THE UPLAND ZONE; HOWEVER, THESE ACTIVITIES MUST BE PERFORMED IN SUCH A MANNER AS TO PREVENT DAMAGE TO THE ROOTS OF REMAINING TREES. GRASS OR OTHER SUITABLE GROUNDCOVER CAN BE APPLIED TO THE UPLAND ZONE...
- 12. THE OUTSIDE BOUNDARY OF THE BUFFER MUST BE CLEARLY MARKED WITH ORANGE FABRIC FENCING PRIOR TO ANY LAND-DISTURBING ACTIVITIES (GRADING, TREE-CUTTING OR STUMPING, ETC) AT THE SITE AND THIS FENCING MUST BE CALLED OUT ON THE PLANS.
- 13. THE OUTSIDE BOUNDARY OF THE STREAM BUFFER MUST BE PERMANENTLY MARKED WITH IRON PIN OR OTHER ACCEPTABLE PROPERTY CORNER MARKER AT STREET CROSSINGS AND THIS MARKER MUST BE CALLED OUT ON THE PLANS.
- 14. ANY ACTIVITY IN THE BUFFER MUST ALSO COMPLY WITH THE ACCEPTABLE ZONING
- 15. STREAM BUFFERS MUST BE SURVEYED AND CLEARLY MARKED IN THE FIELD PRIOR TO THE PRE-CONTRUCTION MEETING WITH THE WATER QUALITY STAFF

TOTAL DENUDED AREA = 0.8 ACRES

BID SET - NOT FOR CONSTRUCTION








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SCALE: NTS

DATE: 3-12-25

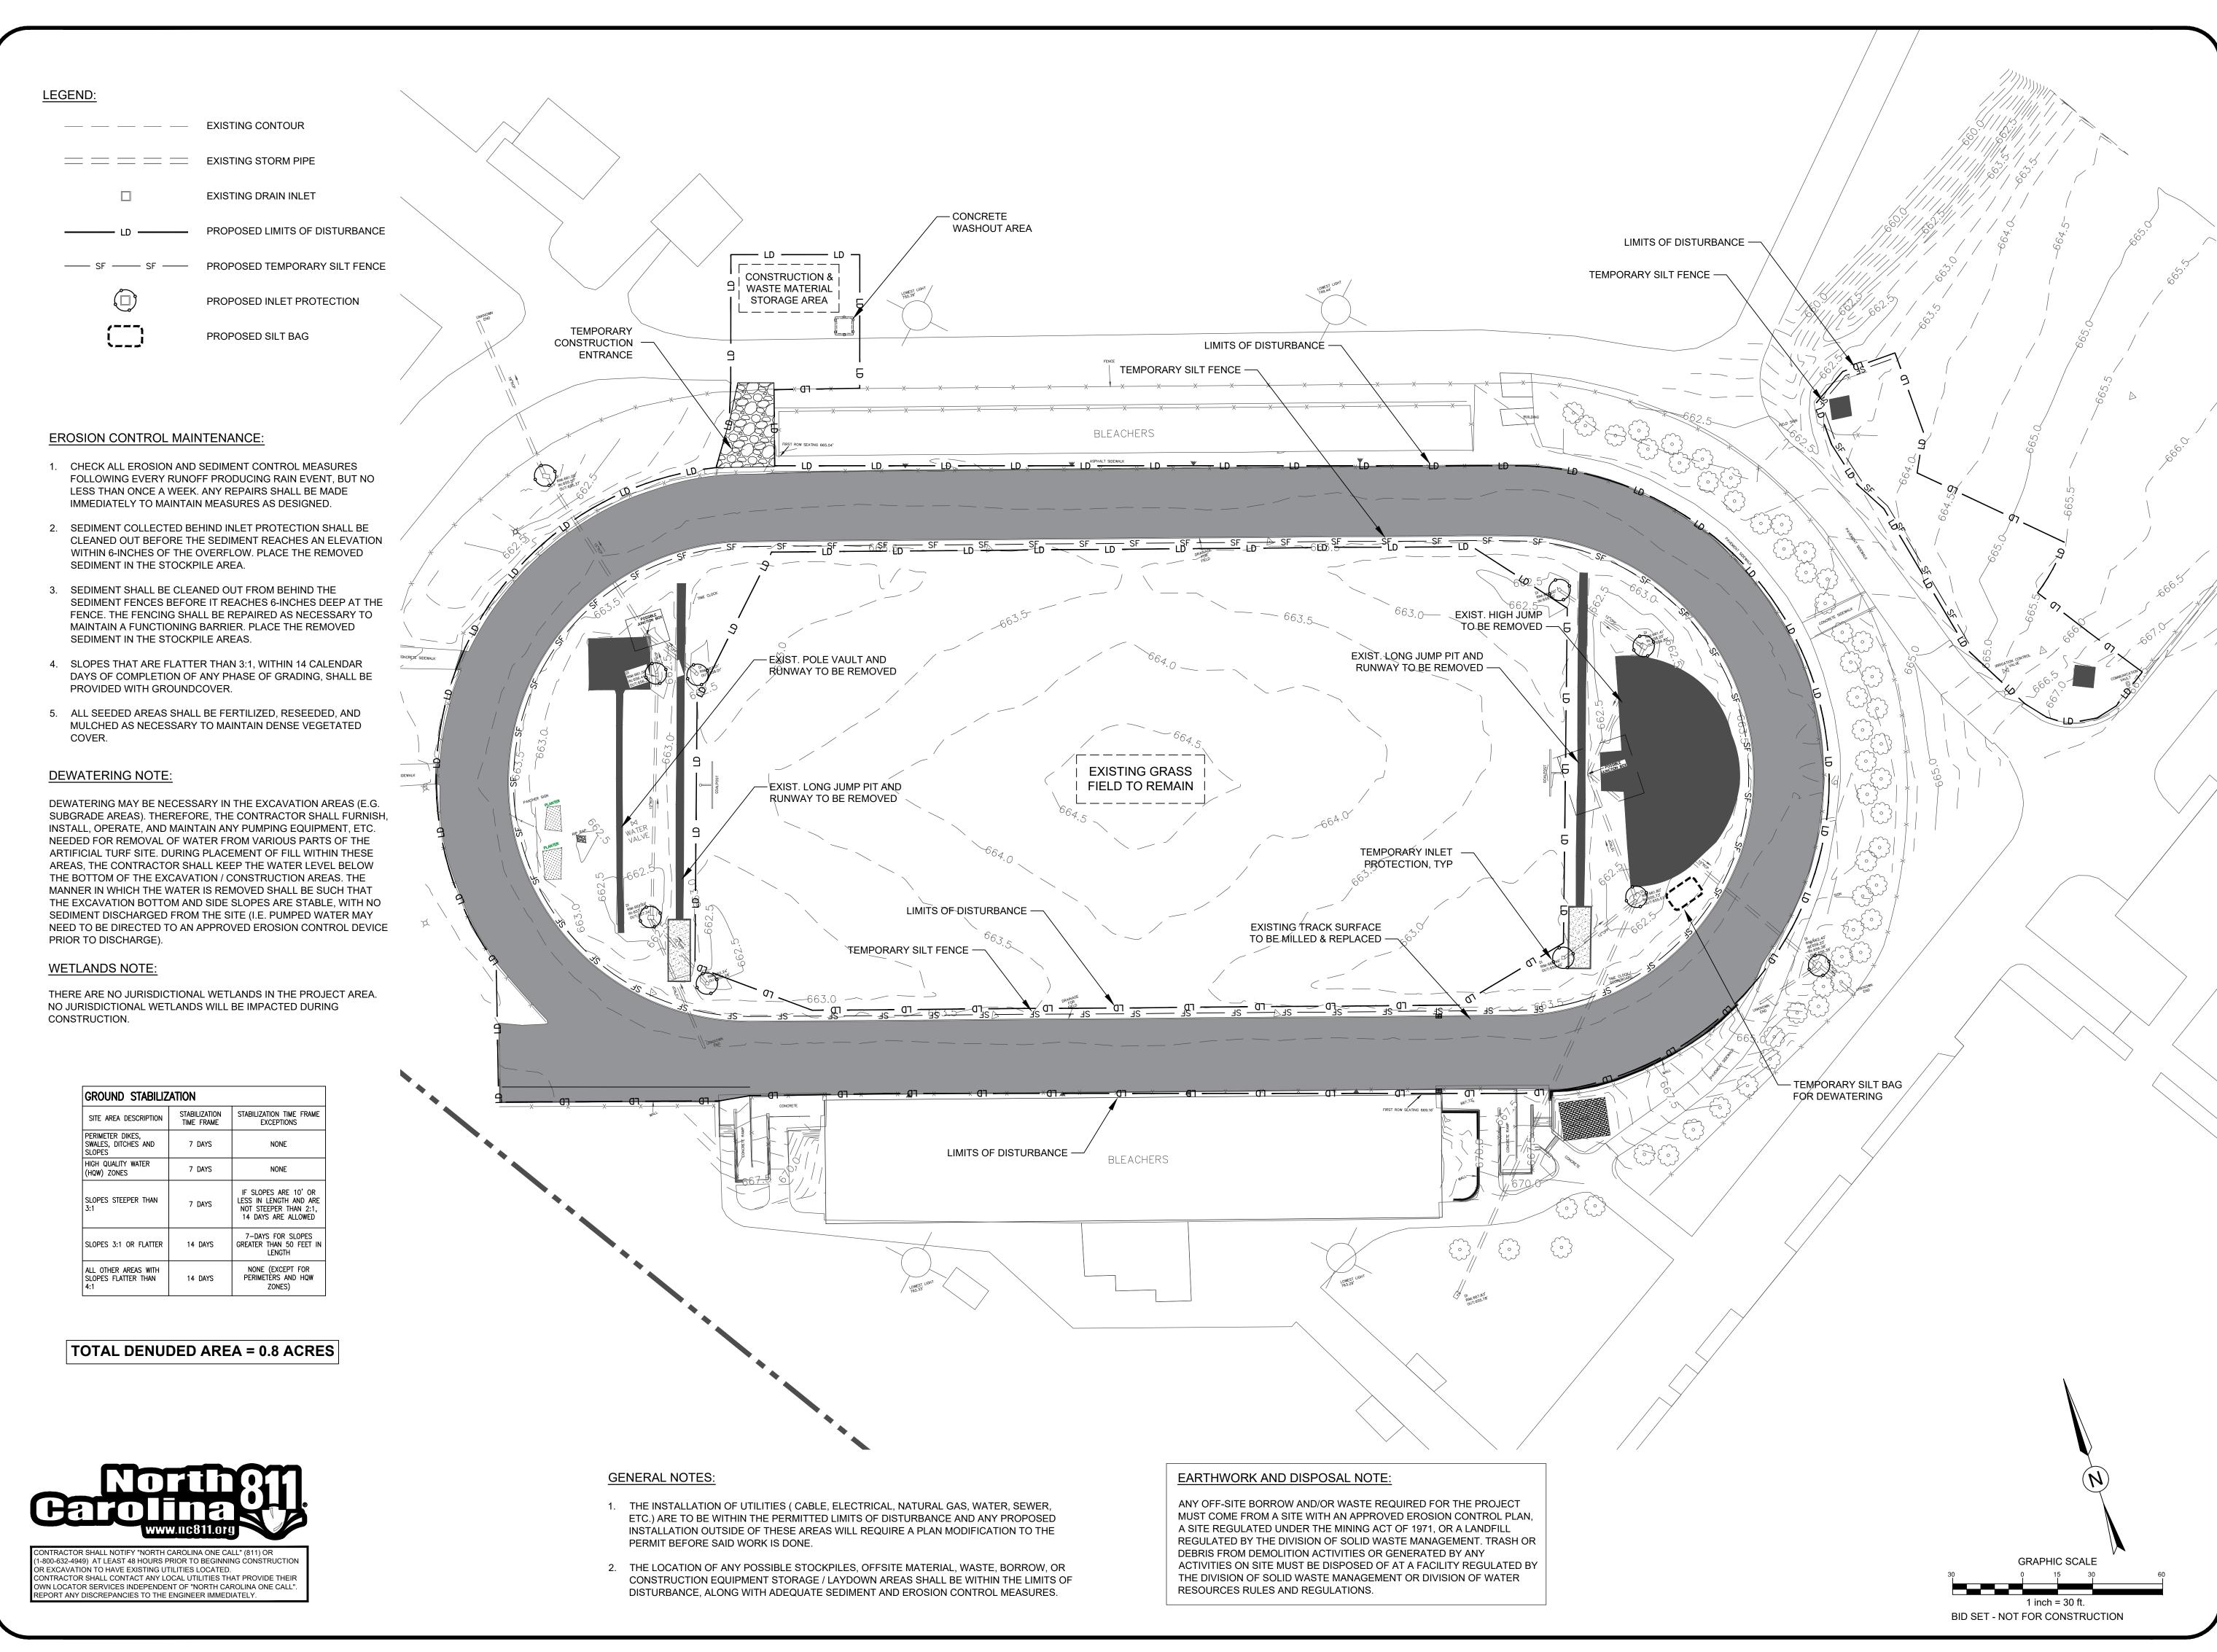
SHEET NAME: GENERAL AND **EROSION** CONTROL NOTES



CORPORATE

SCALE: 1" = 30'-0" DATE: 3-12-25

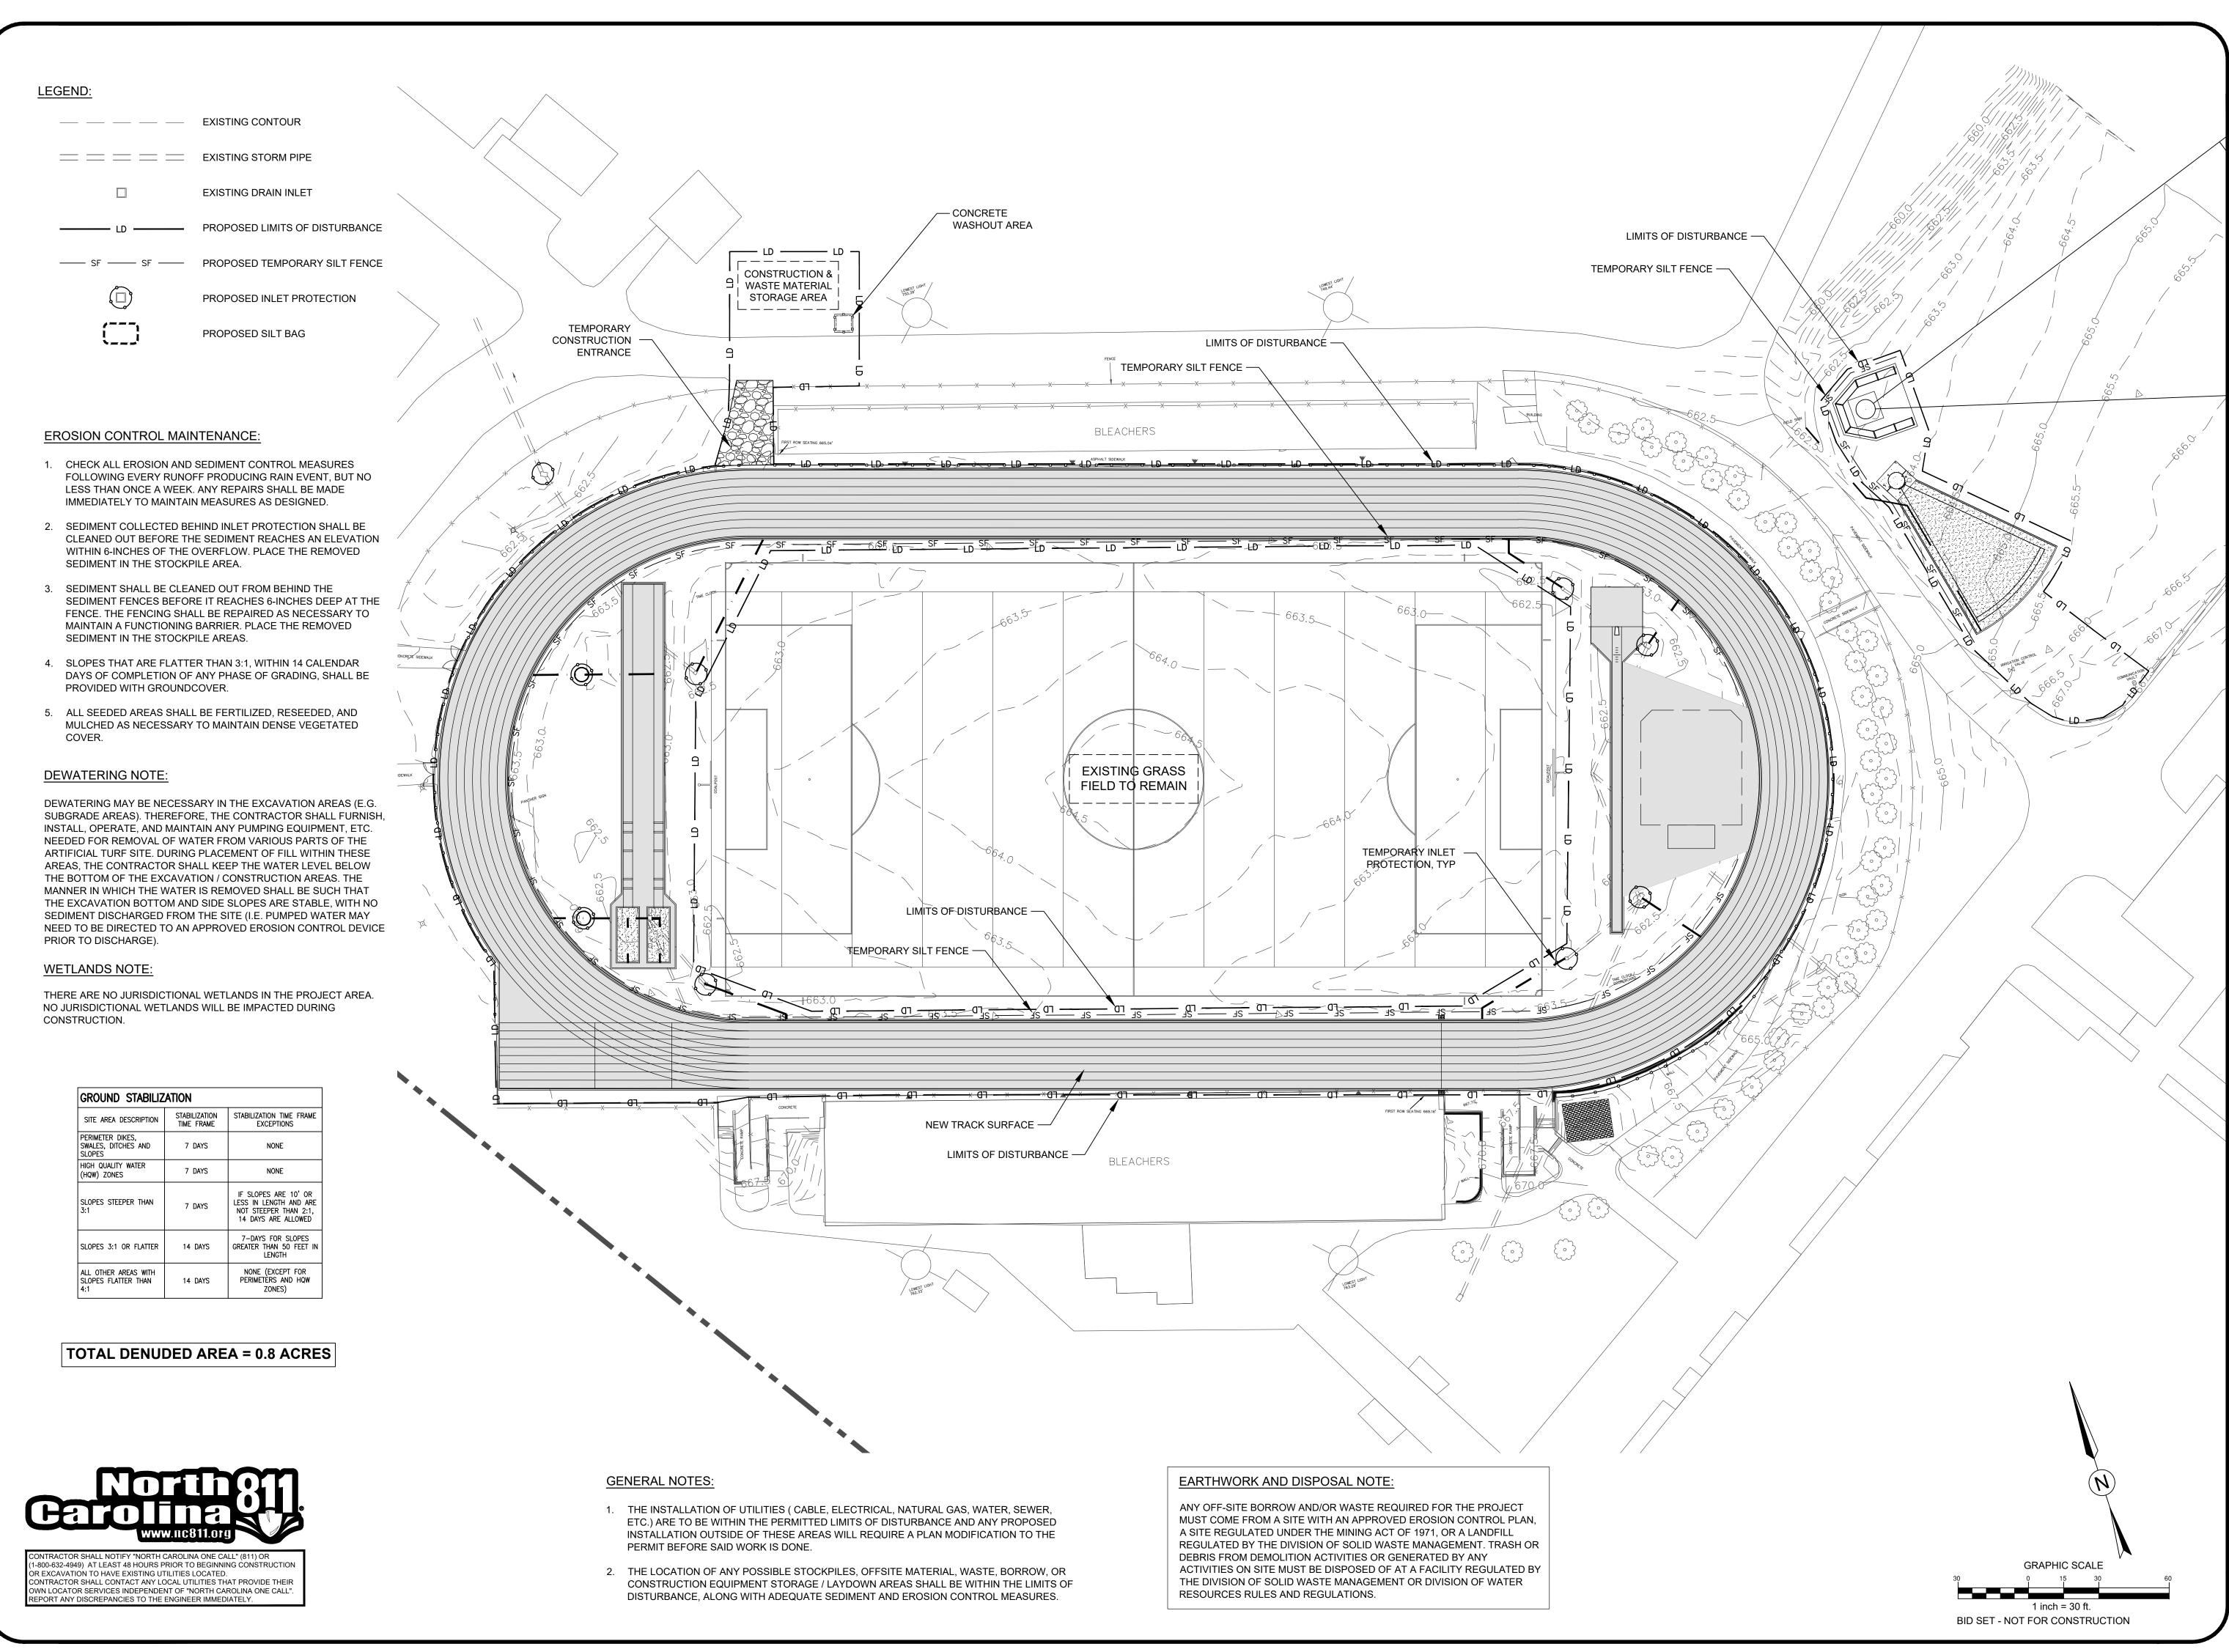
SHEET NAME: PHASE 1 **EROSION** CONTROL PLAN



CORPORATE

SCALE: 1" = 30'-0" DATE: 3-12-25

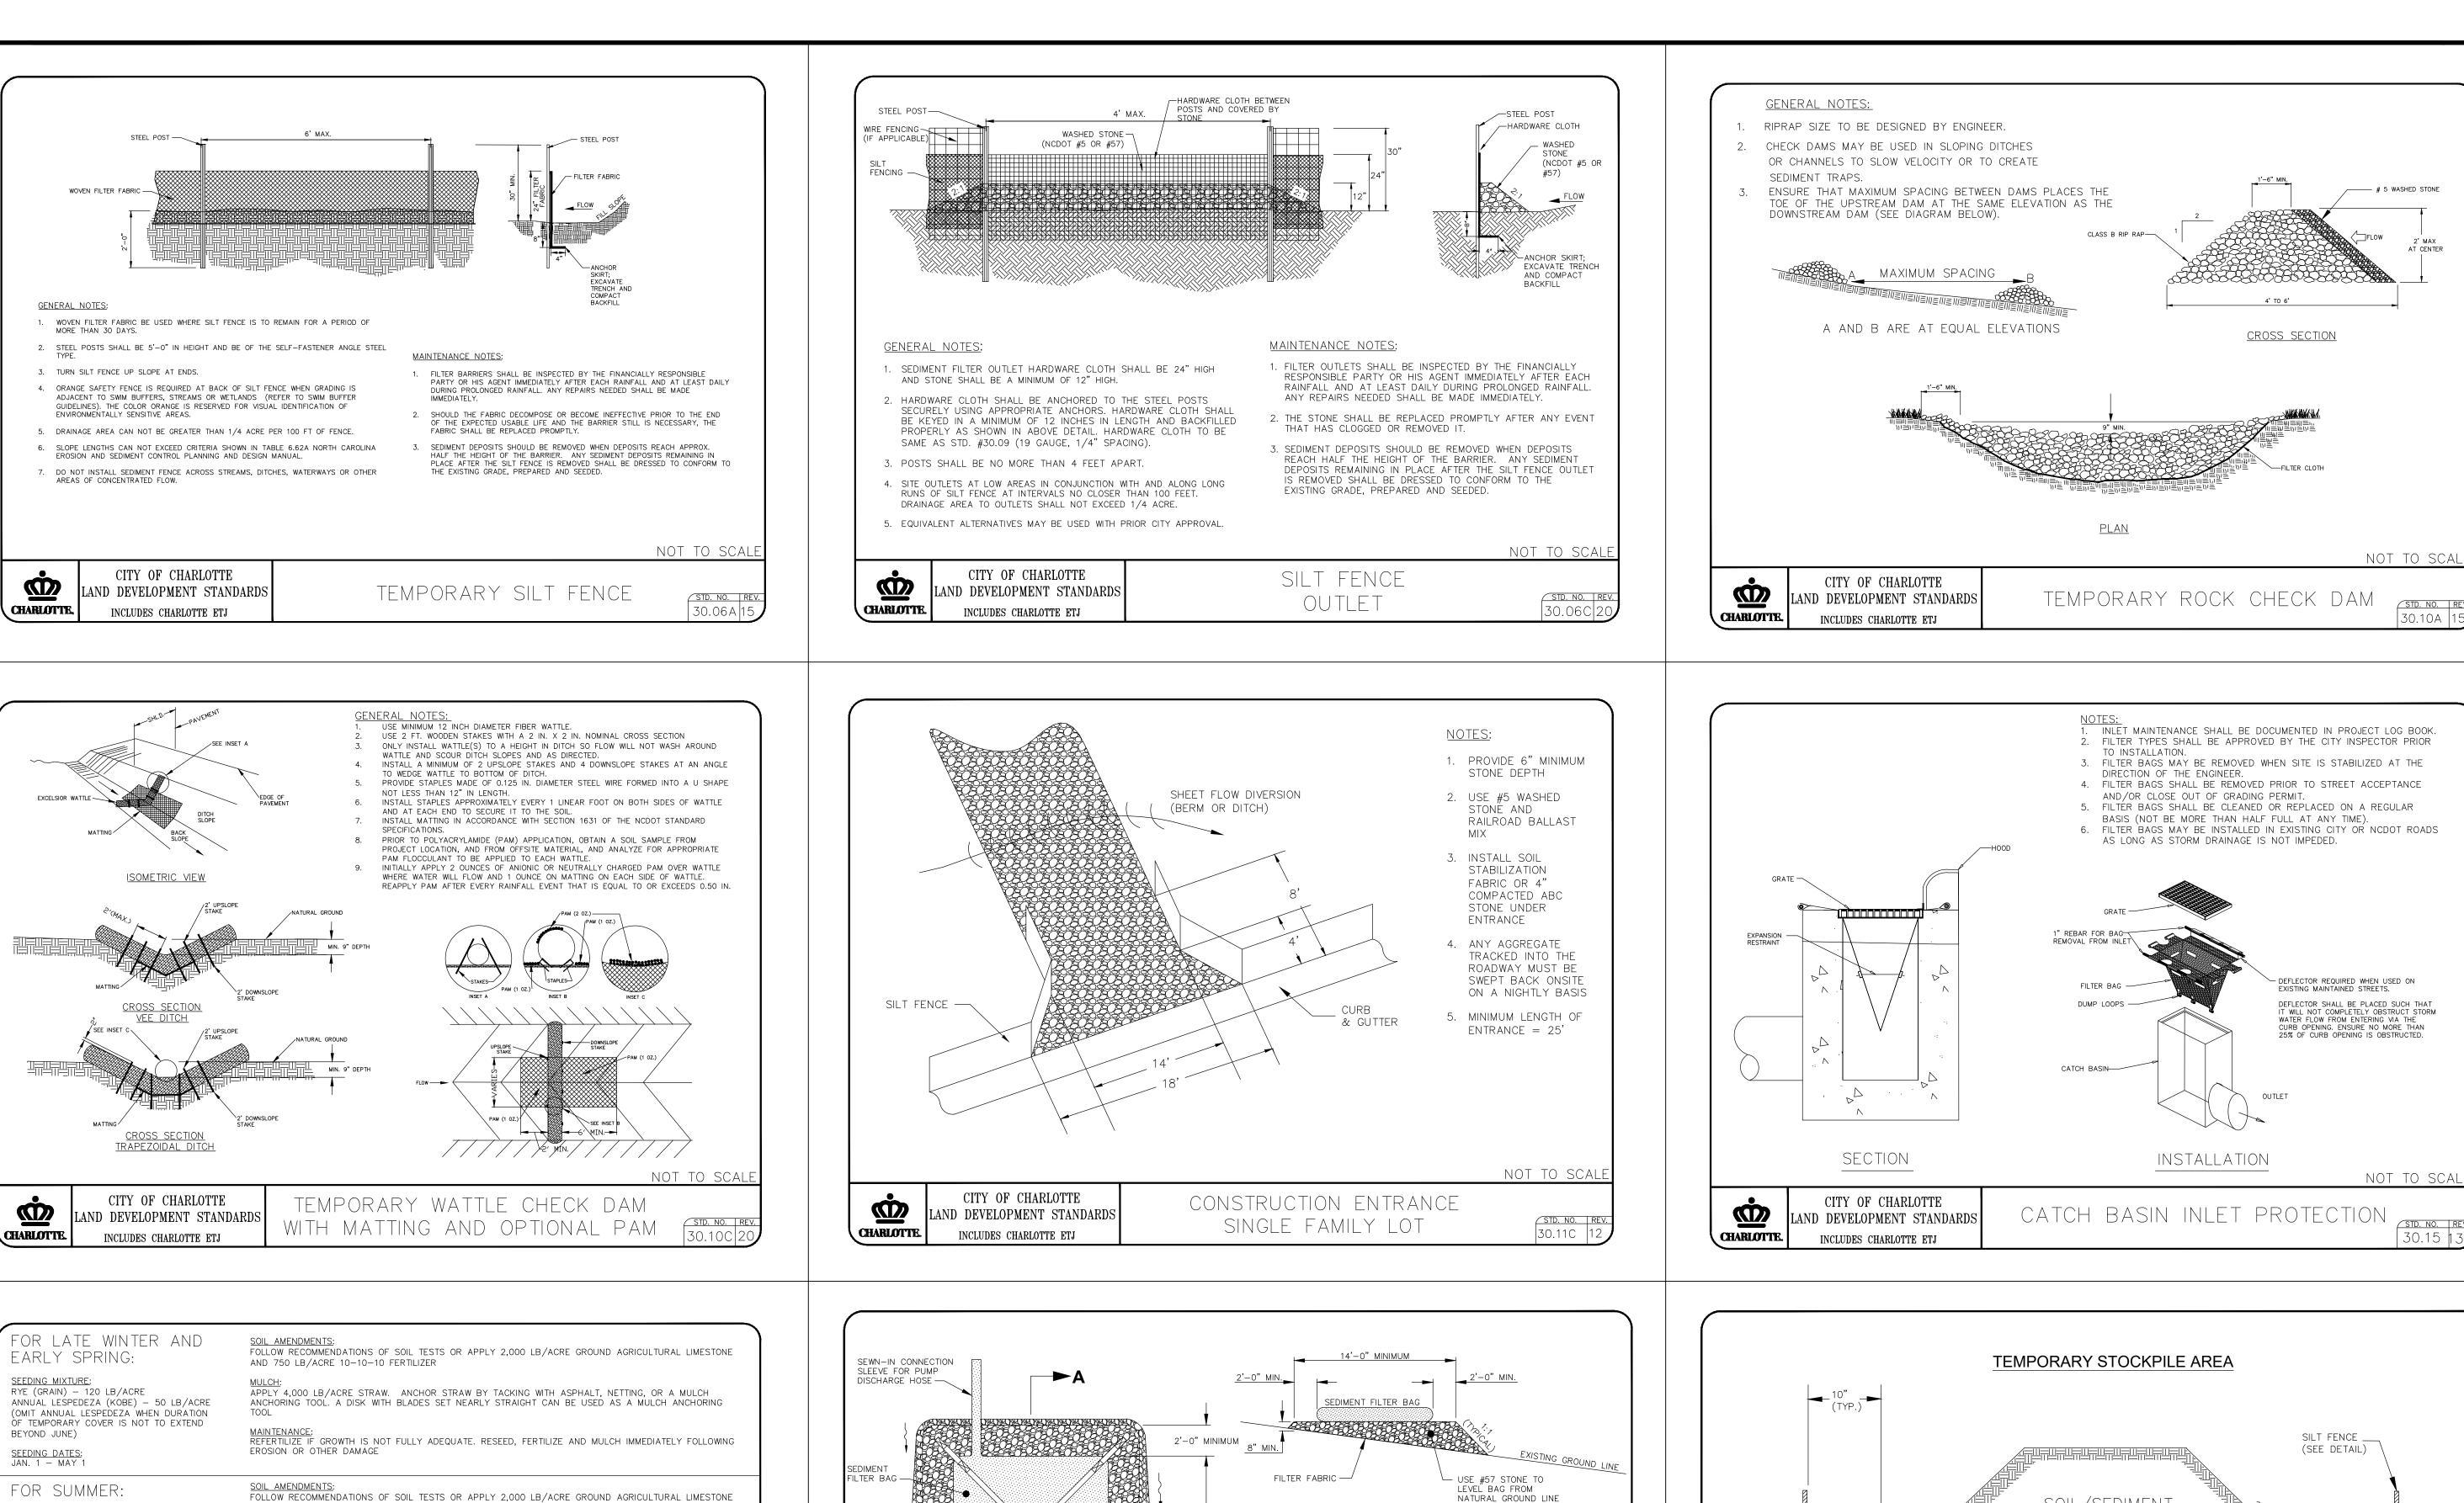SHEET NAME: PHASE 2 **EROSION** CONTROL PLAN



AND 750 LB/ACRE 10-10-10 FERTILIZER

FOR ADDITIONAL INFORMATION, REFER TO NCDENR EROSION AND SEDIMENT CONTROL PLANNING AND DESIGN MANUAL (ESCPDM), SECTION 6.10.

FOR PERMANENT SEEDING SPECIFICATIONS, INCLUDING SEED BED PREP, SEASONAL LIMITATIONS FOR SEEDING OPERATIONS, THE KINDS OF GRADES OF FERTILIZERS, THE KINDS OF SEED, AND THE RATES OF APPLICATION OF LIMESTONE, FERTILIZER, AND SEED, REFER TO NCDENR ESCPDM SECTION 6.11 AND THE CHARLOTTE LANDSCAPE CONSTRUCTION STANDARDS SECTION 04200 SEEDING AND SODDING OF TURFGRASS.

LIMESTONE AND 1,000 LB/ACRE 10-10-10 FERTILIZER

LB/ACRE KOBE LESPEDEZA IN LATE FEBRUARY OR EARLY MARCH.

EROSION OR OTHER DAMAGE

APPLY 4,000 LB/ACRE STRAW. ANCHOR STRAW BY TACKING WITH ASPHALT, NETTING, OR A MULCH

FOLLOW RECOMMENDATIONS OF SOIL TESTS OR APPLY 2,000 LB/ACRE GROUND AGRICULTURAL

APPLY 4,000 LB/ACRE STRAW. ANCHOR STRAW BY TACKING WITH ASPHALT, NETTING, OR A MULCH

ANCHORING TOOL. A DISK WITH BLADES SET NEARLY STRAIGHT CAN BE USED AS A MULCH ANCHORING

REPAIR AND REFERTILIZE DAMAGED AREAS IMMEDIATELY. TOPDRESS WITH 50 LB/ACRE OF NITROGEN IN MARCH. IF IT IS NECESSARY TO EXTEND TEMPORARY COVER BEYOND JUNE 15, OVERSEED WITH 50

TEMPORARY SEEDING SCHEDULE

ANCHORING TOOL. A DISK WITH BLADES SET NEARLY STRAIGHT CAN BE USED AS A MULCH ANCHORING

MAINTENANCE:
REFERTILIZE IF GROWTH IS NOT FULLY ADEQUATE. RESEED, FERTILIZE AND MULCH IMMEDIATELY FOLLOWING

STRAPS-

SEEDING MIXTURE: GERMAN MILLET - 40 LB/ACRE

<u>SEEDING DATES:</u> MAY 1 - AUG. 15

FOR FALL:

SEEDING DATES: AUG. 15 — DEC 30

CHARLOTTE.

<u>SEEDING MIXTURE:</u> RYE (GRAIN) — 120 LB/ACRE

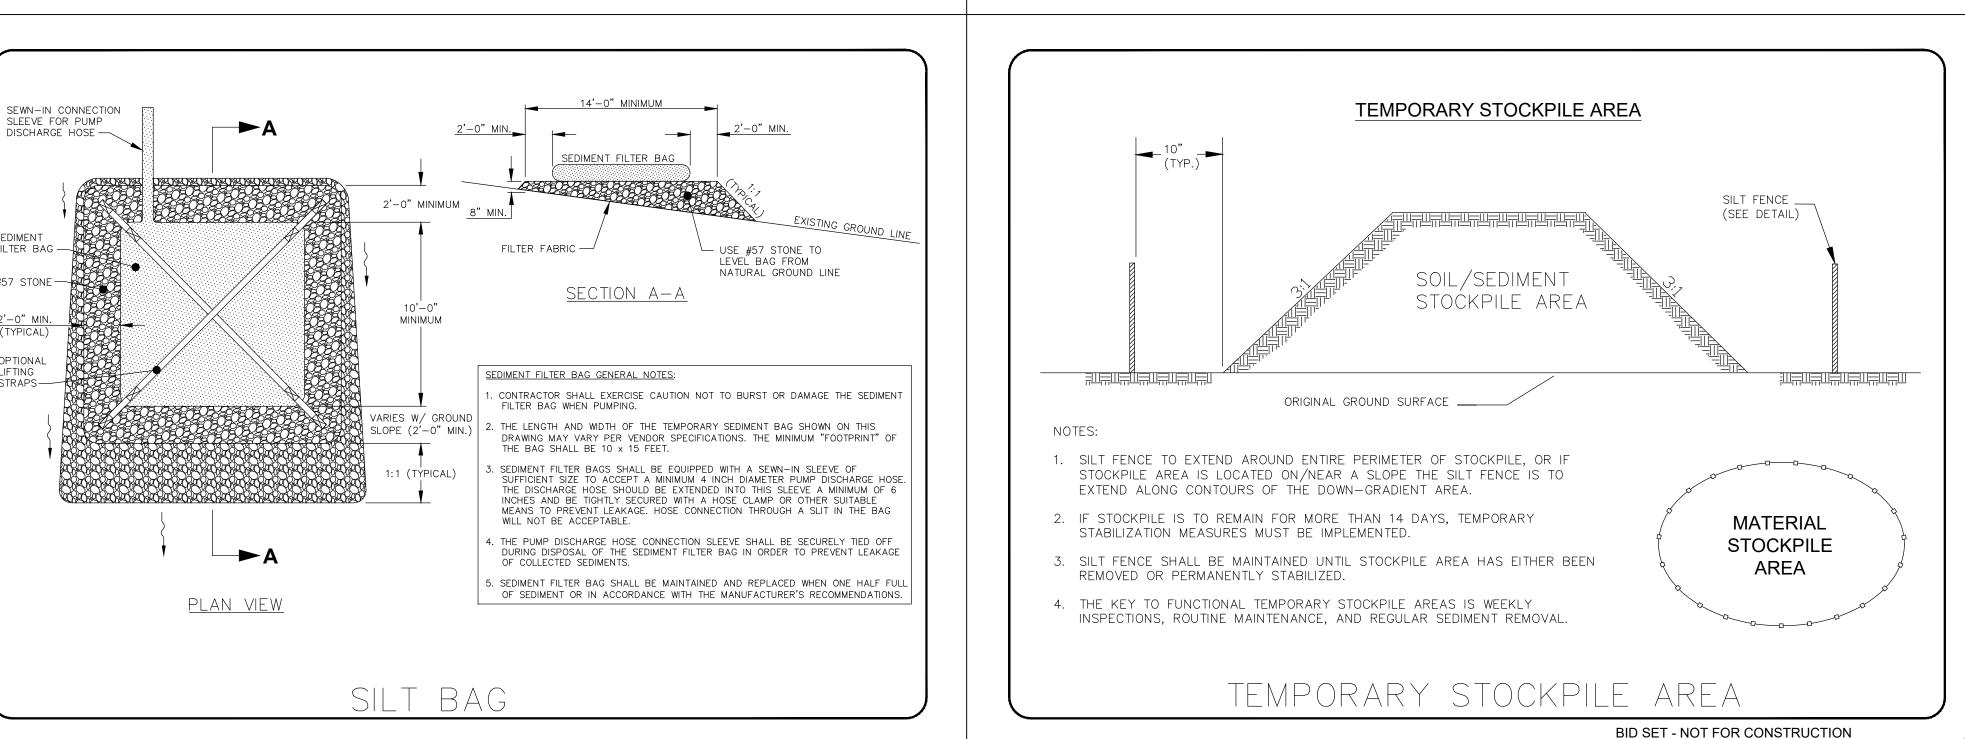
(A SMALL-STEMMED SUDANGRASS MAY BE

SUBSTITUTED AT A RATE OF 50 LB/ACRE)

CITY OF CHARLOTTE

AND DEVELOPMENT STANDARD

INCLUDES CHARLOTTE ETJ



SCALE: NTS

CORPORATE

SEAL

P-1266

DATE: 3-12-25 SHEET NAME:

EROSION CONTROL DETAILS

Implementing the details and specifications on this plan sheet will result in the construction activity being considered compliant with the Ground Stabilization and Materials Handling sections of the NCG01 Construction General Permit (Sections E and F, respectively). The permittee shall comply with the Erosion and Sediment Control plan approved by the delegated authority having jurisdiction. All details and specifications shown on this sheet may not apply depending on site conditions and the delegated authority having jurisdiction.

SECTION E: GROUND STABILIZATION

| | Required Ground Stabilization Timeframes | | | | | |
|-----|--|---|---|--|--|--|
| Si | ite Area Description | Stabilize within this many calendar days after ceasing land disturbance | Timeframe variations | | | |
| (a) | Perimeter dikes, swales, ditches, and perimeter slopes | 7 | None | | | |
| (b) | High Quality Water (HQW) Zones | 7 | None | | | |
| (c) | Slopes steeper than 3:1 | 7 | If slopes are 10' or less in length and are not steeper than 2:1, 14 days are allowed | | | |
| (d) | Slopes 3:1 to 4:1 | 14 | -7 days for slopes greater than 50' in length and with slopes steeper than 4:1 -7 days for perimeter dikes, swales, ditches, perimeter slopes and HQW Zones -10 days for Falls Lake Watershed | | | |
| (e) | Areas with slopes flatter than 4:1 | 14 | -7 days for perimeter dikes, swales, ditches, perimeter slopes and HQW Zones -10 days for Falls Lake Watershed unless there is zero slope | | | |

Note: After the permanent cessation of construction activities, any areas with temporary ground stabilization shall be converted to permanent ground stabilization as soon as practicable but in no case longer than 90 calendar days after the last land disturbing activity. Temporary ground stabilization shall be maintained in a manner to render the surface stable against accelerated erosion until permanent ground stabilization is achieved.

GROUND STABILIZATION SPECIFICATION

Stabilize the ground sufficiently so that rain will not dislodge the soil. Use one of the techniques in the table below:

| Temporary Stabilization | Permanent Stabilization |
|---|---|
| Temporary grass seed covered with straw or other mulches and tackifiers Hydroseeding Rolled erosion control products with or without temporary grass seed Appropriately applied straw or other mulch Plastic sheeting | Permanent grass seed covered with straw or other mulches and tackifiers Geotextile fabrics such as permanent soil reinforcement matting Hydroseeding Shrubs or other permanent plantings covered with mulch Uniform and evenly distributed ground cover sufficient to restrain erosion Structural methods such as concrete, asphalt or |
| | retaining walls |
| | Rolled erosion control products with grass seed |

POLYACRYLAMIDES (PAMS) AND FLOCCULANTS

- 1. Select flocculants that are appropriate for the soils being exposed during construction, selecting from the NC DWR List of Approved PAMS/Flocculants.
- 2. Apply flocculants at or before the inlets to Erosion and Sediment Control Measures.
- 3. Apply flocculants at the concentrations specified in the NC DWR List of Approved PAMS/Flocculants and in accordance with the manufacturer's instructions.
- 4. Provide ponding area for containment of treated Stormwater before discharging offsite.
- 5. Store flocculants in leak-proof containers that are kept under storm-resistant cover or surrounded by secondary containment structures.

EQUIPMENT AND VEHICLE MAINTENANCE

- .. Maintain vehicles and equipment to prevent discharge of fluids.
- 2. Provide drip pans under any stored equipment.
- 3. Identify leaks and repair as soon as feasible, or remove leaking equipment from the project.
- 4. Collect all spent fluids, store in separate containers and properly dispose as hazardous waste (recycle when possible).
- 5. Remove leaking vehicles and construction equipment from service until the problem has been corrected.
- 6. Bring used fuels, lubricants, coolants, hydraulic fluids and other petroleum products to a recycling or disposal center that handles these materials.

LITTER, BUILDING MATERIAL AND LAND CLEARING WASTE

- 1. Never bury or burn waste. Place litter and debris in approved waste containers.
- 2. Provide a sufficient number and size of waste containers (e.g dumpster, trash receptacle) on site to contain construction and domestic wastes.
- 3. Locate waste containers at least 50 feet away from storm drain inlets and surface waters unless no other alternatives are reasonably available.
- 4. Locate waste containers on areas that do not receive substantial amounts of runoff from upland areas and does not drain directly to a storm drain, stream or wetland.
- 5. Cover waste containers at the end of each workday and before storm events or provide secondary containment. Repair or replace damaged waste containers.
- 6. Anchor all lightweight items in waste containers during times of high winds.
- 7. Empty waste containers as needed to prevent overflow. Clean up immediately if containers overflow.
- 8. Dispose waste off-site at an approved disposal facility.
- On business days, clean up and dispose of waste in designated waste containers.

PAINT AND OTHER LIQUID WASTE

- 1. Do not dump paint and other liquid waste into storm drains, streams or wetlands.
- 2. Locate paint washouts at least 50 feet away from storm drain inlets and surface waters unless no other alternatives are reasonably available.
- 3. Contain liquid wastes in a controlled area.
- I. Containment must be labeled, sized and placed appropriately for the needs of site.
- Prevent the discharge of soaps, solvents, detergents and other liquid wastes from construction sites.

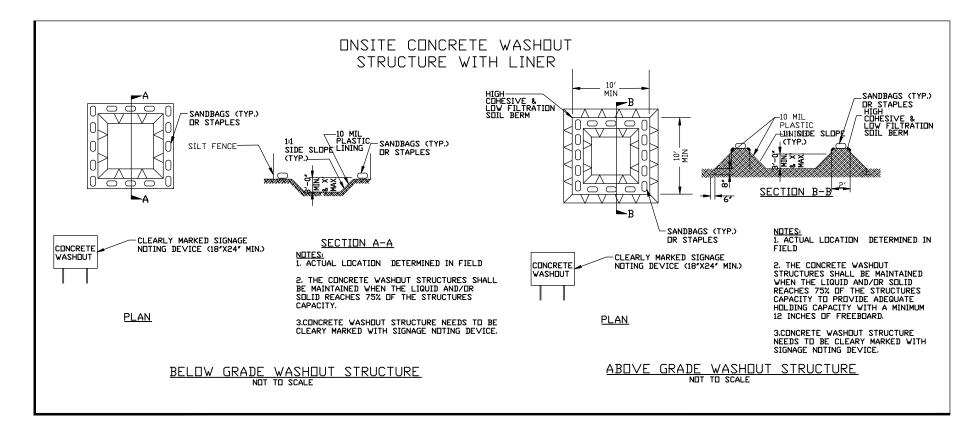
PORTABLE TOILETS

- 1. Install portable toilets on level ground, at least 50 feet away from storm drains, streams or wetlands unless there is no alternative reasonably available. If 50 foot offset is not attainable, provide relocation of portable toilet behind silt fence or place on a gravel pad and surround with sand bags.
- 2. Provide staking or anchoring of portable toilets during periods of high winds or in high foot traffic areas.
- 3. Monitor portable toilets for leaking and properly dispose of any leaked material.

 Utilize a licensed sanitary waste hauler to remove leaking portable toilets and replace with properly operating unit.

EARTHEN STOCKPILE MANAGEMENT

- 1. Show stockpile locations on plans. Locate earthen-material stockpile areas at least 50 feet away from storm drain inlets, sediment basins, perimeter sediment controls and surface waters unless it can be shown no other alternatives are reasonably available.
- Protect stockpile with silt fence installed along toe of slope with a minimum offset of five feet from the toe of stockpile.
- 3. Provide stable stone access point when feasible.
- . Stabilize stockpile within the timeframes provided on this sheet and in accordance with the approved plan and any additional requirements. Soil stabilization is defined as vegetative, physical or chemical coverage techniques that will restrain accelerated erosion on disturbed soils for temporary or permanent control needs.



CONCRETE WASHOUTS

- 1. Do not discharge concrete or cement slurry from the site.
- 2. Dispose of, or recycle settled, hardened concrete residue in accordance with local and state solid waste regulations and at an approved facility.
- 3. Manage washout from mortar mixers in accordance with the above item and in addition place the mixer and associated materials on impervious barrier and within lot perimeter silt fence.
- 4. Install temporary concrete washouts per local requirements, where applicable. If an alternate method or product is to be used, contact your approval authority for review and approval. If local standard details are not available, use one of the two types of temporary concrete washouts provided on this detail.
- 5. Do not use concrete washouts for dewatering or storing defective curb or sidewalk sections. Stormwater accumulated within the washout may not be pumped into or discharged to the storm drain system or receiving surface waters. Liquid waste must be pumped out and removed from project.
- 6. Locate washouts at least 50 feet from storm drain inlets and surface waters unless it can be shown that no other alternatives are reasonably available. At a minimum, install protection of storm drain inlet(s) closest to the washout which could receive spills or overflow.
- 7. Locate washouts in an easily accessible area, on level ground and install a stone entrance pad in front of the washout. Additional controls may be required by the approving authority.
- 8. Install at least one sign directing concrete trucks to the washout within the project limits. Post signage on the washout itself to identify this location.
- 9. Remove leavings from the washout when at approximately 75% capacity to limit overflow events. Replace the tarp, sand bags or other temporary structural components when no longer functional. When utilizing alternative or proprietary products, follow manufacturer's instructions.
- 10. At the completion of the concrete work, remove remaining leavings and dispose of in an approved disposal facility. Fill pit, if applicable, and stabilize any disturbance caused by removal of washout.

HERBICIDES, PESTICIDES AND RODENTICIDES

- 1. Store and apply herbicides, pesticides and rodenticides in accordance with label restrictions.
- Store herbicides, pesticides and rodenticides in their original containers with the label, which lists directions for use, ingredients and first aid steps in case of accidental poisoning.
- 3. Do not store herbicides, pesticides and rodenticides in areas where flooding is possible or where they may spill or leak into wells, stormwater drains, ground water or surface water. If a spill occurs, clean area immediately.
- 4. Do not stockpile these materials onsite.

HAZARDOUS AND TOXIC WASTE


- 1. Create designated hazardous waste collection areas on-site.
- 2. Place hazardous waste containers under cover or in secondary containment.
- 3. Do not store hazardous chemicals, drums or bagged materials directly on the ground.


NCG01 GROUND STABILIZATION AND MATERIALS HANDLING

EFFECTIVE: 04/01/19

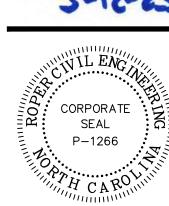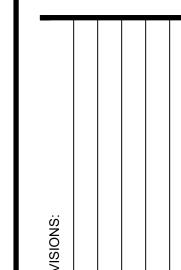EDGINER I







CHARLOTTE MECKLENBURG
BOARD OF EDUCATION
POST OFFICE BOX 30035
CHARLOTTE, NC 28230

AOVIDENCE HIGH SCHOOL
TRACK RENOVATIONS
1800 PINEVILLE-MATTHEWS ROAD
CHARLOTTE, NC 28270

SCALE: NTS

DATE: 3-12-25

SHEET NAME:
EROSION
CONTROL
DETAILS

SHEET NO:

BID SET - NOT FOR CONSTRUCTION

SECTION A: SELF-INSPECTION

Self-inspections are required during normal business hours in accordance with the table below. When adverse weather or site conditions would cause the safety of the inspection personnel to be in jeopardy, the inspection may be delayed until the next business day on which it is safe to perform the inspection. In addition, when a storm event of equal to or greater than 1.0 inch occurs outside of normal business hours, the self-inspection shall be performed upon the commencement of the next business day. Any time when inspections were delayed shall be noted in the Inspection Record.

| Inspect | Frequency (during normal business hours) | Inspection records must include: |
|--|--|--|
| (1) Rain gauge maintained in good working order | Daily | Daily rainfall amounts. If no daily rain gauge observations are made during weekend holiday periods, and no individual-day rainfall information available, record the cumulative rain measurement for those attended days (and this will determine if a site inspection needed). Days on which no rainfall occurred shall be recorde "zero." The permittee may use another rain-monitoring deapproved by the Division. |
| (2) E&SC Measures | At least once per 7 calendar days and within 24 hours of a rain event ≥ 1.0 inch in 24 hours | Identification of the measures inspected, Date and time of the inspection, Name of the person performing the inspection, Indication of whether the measures were operating properly, Description of maintenance needs for the measure, Description, evidence, and date of corrective actions taken. |
| (3) Stormwater discharge outfalls (SDOs) | At least once per 7 calendar days and within 24 hours of a rain event ≥ 1.0 inch in 24 hours | Identification of the discharge outfalls inspected, Date and time of the inspection, Name of the person performing the inspection, Evidence of indicators of stormwater pollution such as oil sheen, floating or suspended solids or discoloration, Indication of visible sediment leaving the site, Description, evidence, and date of corrective actions taken. |
| (4) Perimeter of site | At least once per 7 calendar days and within 24 hours of a rain event > 1.0 inch in 24 hours | If visible sedimentation is found outside site limits, then a record of the following shall be made: Actions taken to clean up or stabilize the sediment that has lithe site limits, Description, evidence, and date of corrective actions taken, An explanation as to the actions taken to control future releases. |
| (5) Streams or wetlands onsite or offsite (where accessible) | At least once per 7 calendar days and within 24 hours of a rain event ≥ 1.0 inch in 24 hours | If the stream or wetland has increased visible sedimentation or stream has visible increased turbidity from the construction activity, then a record of the following shall be made: 1. Description, evidence and date of corrective actions taken, at 2. Records of the required reports to the appropriate Division Regional Office per Part III, Section C, Item (2)(a) of this pern |
| (6) Ground stabilization measures | After each phase of grading | The phase of grading (installation of perimeter E&SC measures, clearing and grubbing, installation of storm drainage facilities, completion of all land-disturbing activity, construction or redevelopment, permanent ground cover). Documentation that the required ground stabilization measures have been provided within the required timeframe or an assurance that they will be provided as soon as possible. |

NOTE: The rain inspection resets the required 7 calendar day inspection requirement

PART III SELF-INSPECTION, RECORDKEEPING AND REPORTING

SECTION B: RECORDKEEPING

1. E&SC Plan Documentation

The approved E&SC plan as well as any approved deviation shall be kept on the site. The approved E&SC plan must be kept up-to-date throughout the coverage under this permit. The following items pertaining to the E&SC plan shall be kept on site and available for inspection at all times during normal business hours.

| Item to Document | Documentation Requirements |
|---|---|
| (a) Each E&SC measure has been installed and does not significantly deviate from the locations, dimensions and relative elevations shown on the approved E&SC plan. | Initial and date each E&SC measure on a copy of the approved E&SC plan or complete, date and sign an inspection report that lists each E&SC measure shown on the approved E&SC plan. This documentation is required upon the initial installation of the E&SC measures or if the E&SC measures are modified after initial installation. |
| (b) A phase of grading has been completed. | Initial and date a copy of the approved E&SC plan or complete, date and sign an inspection report to indicate completion of the construction phase. |
| (c) Ground cover is located and installed in accordance with the approved E&SC plan. | Initial and date a copy of the approved E&SC plan or complete, date and sign an inspection report to indicate compliance with approved ground cover specifications. |
| (d) The maintenance and repair requirements for all E&SC measures have been performed. | Complete, date and sign an inspection report. |
| (e) Corrective actions have been taken to E&SC measures. | Initial and date a copy of the approved E&SC plan or complete, date and sign an inspection report to indicate the completion of the corrective action. |

2. Additional Documentation to be Kept on Site

In addition to the E&SC plan documents above, the following items shall be kept on the site and available for inspectors at all times during normal business hours, unless the Division provides a site-specific exemption based on unique site conditions that make this requirement not practical:

- (a) This General Permit as well as the Certificate of Coverage, after it is received.
- (b) Records of inspections made during the previous twelve months. The permittee shall record the required observations on the Inspection Record Form provided by the Division or a similar inspection form that includes all the required elements. Use of electronically-available records in lieu of the required paper copies will be allowed if shown to provide equal access and utility as the hard-copy records.

3. Documentation to be Retained for Three Years

All data used to complete the e-NOI and all inspection records shall be maintained for a period of three years after project completion and made available upon request. [40 CFR 122.41]

PART II, SECTION G, ITEM (4) DRAW DOWN OF SEDIMENT BASINS FOR MAINTENANCE OR CLOSE OUT

Sediment basins and traps that receive runoff from drainage areas of one acre or more shall use outlet structures that withdraw water from the surface when these devices need to be drawn down for maintenance or close out unless this is infeasible. The circumstances in which it is not feasible to withdraw water from the surface shall be rare (for example, times with extended cold weather) Non-surface withdrawals from sediment basins shall be allowed only when all of the following criteria have been met:

- (a) The E&SC plan authority has been provided with documentation of the non-surface withdrawal and the specific time periods or conditions in which it will occur. The non-surface withdrawal shall not commence until the E&SC plan authority has approved these items,
- The non-surface withdrawal has been reported as an anticipated bypass in accordance with Part III, Section C, Item (2)(c) and (d) of this permit,
- Dewatering discharges are treated with controls to minimize discharges of pollutants from stormwater that is removed from the sediment basin. Examples of appropriate controls include properly sited, designed and maintained dewatering tanks, weir tanks, and filtration systems,
- (d) Vegetated, upland areas of the sites or a properly designed stone pad is used to the extent feasible at the outlet of the dewatering treatment devices described in Item (c) above,
- Velocity dissipation devices such as check dams, sediment traps, and riprap are provided at the discharge points of all dewatering devices, and
- Sediment removed from the dewatering treatment devices described in Item (c) above is disposed of in a manner that does not cause deposition of sediment into waters of the United States.

PART III SELF-INSPECTION, RECORDKEEPING AND REPORTING

SECTION C: REPORTING

1. Occurrences that Must be Reported

Permittees shall report the following occurrences:

- (a) Visible sediment deposition in a stream or wetland.
- (b) Oil spills if:
 - They are 25 gallons or more,

 - They are within 100 feet of surface waters (regardless of volume).
- (c) Releases of hazardous substances in excess of reportable quantities under Section 311 of the Clean Water Act (Ref: 40 CFR 110.3 and 40 CFR 117.3) or Section 102 of CERCLA
- (d) Anticipated bypasses and unanticipated bypasses.
- (e) Noncompliance with the conditions of this permit that may endanger health or the

2. Reporting Timeframes and Other Requirements

After a permittee becomes aware of an occurrence that must be reported, he shall contact the appropriate Division regional office within the timeframes and in accordance with the other requirements listed below. Occurrences outside normal business hours may also be reported to the Department's Environmental Emergency Center personnel at (800) 858-0368.

| 030 0300. | |
|---|---|
| Occurrence | Reporting Timeframes (After Discovery) and Other Requireme |
| (a) Visible sediment deposition in a stream or wetland | Within 24 hours, an oral or electronic notification. Within 7 calendar days, a report that contains a description sediment and actions taken to address the cause of the deportion of the deportion staff may waive the requirement for a written report case-by-case basis. If the stream is named on the NC 303(d) list as impaired for strelated causes, the permittee may be required to perform a monitoring, inspections or apply more stringent practices if strength determine that additional requirements are needed to assur with the federal or state impaired-waters conditions. |
| (b) Oil spills and release of hazardous substances per Item 1(b)-(c) above | Within 24 hours, an oral or electronic notification. The notification include information about the date, time, nature, volunt location of the spill or release. |
| (c) Anticipated bypasses [40 CFR 122.41(m)(3)] | A report at least ten days before the date of the bypass, if p The report shall include an evaluation of the anticipated qua effect of the bypass. |
| (d) Unanticipated bypasses [40 CFR 122.41(m)(3)] | Within 24 hours, an oral or electronic notification. Within 7 calendar days, a report that includes an evaluation quality and effect of the bypass. |
| (e) Noncompliance with the conditions of this permit that may endanger health or the environment[40 CFR 122.41(I)(7)] | Within 24 hours, an oral or electronic notification. Within 7 calendar days, a report that contains a description noncompliance, and its causes; the period of noncompliance including exact dates and times, and if the noncompliance has been corrected, the anticipated time noncompliance is expecontinue; and steps taken or planned to reduce, eliminate, a prevent reoccurrence of the noncompliance. [40 CFR 122.41 Division staff may waive the requirement for a written report case-by-case basis. |

- They are less than 25 gallons but cannot be cleaned up within 24 hours,
- They cause sheen on surface waters (regardless of volume), or
- (Ref: 40 CFR 302.4) or G.S. 143-215.85.
- environment.

| Occurrence | Reporting Timeframes (After Discovery) and Other Requirements |
|---|--|
| (a) Visible sediment deposition in a stream or wetland | Within 24 hours, an oral or electronic notification. Within 7 calendar days, a report that contains a description of the sediment and actions taken to address the cause of the deposition. Division staff may waive the requirement for a written report on a case-by-case basis. If the stream is named on the NC 303(d) list as impaired for sediment-related causes, the permittee may be required to perform additional monitoring, inspections or apply more stringent practices if staff determine that additional requirements are needed to assure compliance with the federal or state impaired-waters conditions. |
| (b) Oil spills and release of hazardous substances per Item 1(b)-(c) above | Within 24 hours, an oral or electronic notification. The notification shall include information about the date, time, nature, volume and location of the spill or release. |
| (c) Anticipated bypasses [40 CFR 122.41(m)(3)] | A report at least ten days before the date of the bypass, if possible. The report shall include an evaluation of the anticipated quality and effect of the bypass. |
| (d) Unanticipated bypasses [40 CFR 122.41(m)(3)] | Within 24 hours, an oral or electronic notification. Within 7 calendar days, a report that includes an evaluation of the quality and effect of the bypass. |
| (e) Noncompliance with the conditions of this permit that may endanger health or the environment[40 CFR 122.41(I)(7)] | Within 24 hours, an oral or electronic notification. Within 7 calendar days, a report that contains a description of the noncompliance, and its causes; the period of noncompliance, including exact dates and times, and if the noncompliance has not been corrected, the anticipated time noncompliance is expected to continue; and steps taken or planned to reduce, eliminate, and prevent reoccurrence of the noncompliance. [40 CFR 122.41(I)(6). Division staff may waive the requirement for a written report on a case-by-case basis. |

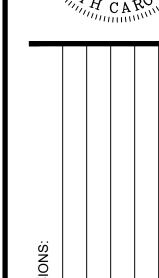
NCG01 SELF-INSPECTION, RECORDKEEPING AND REPORTING

EFFECTIVE: 04/01/19

BID SET - NOT FOR CONSTRUCTION







DATE: 3-12-25 SHEET NAME: **EROSION** CONTROL

DETAILS SHEET NO: C205

LAYOUT NOTES 1. SHOULD ANY DISCREPANCIES BE FOUND IN THE FIELD THE CONTRACTOR SHALL CONTACT THE OWNER AND LANDSCAPE ARCHITECT/SPORT FIELD DESIGNER PRIOR TO PROCEEDING. 2. PRIOR TO BEGINNING CONSTRUCTION, THE CONTRACTOR SHALL BE RESPONSIBLE FOR VERIFYING THAT ALL REQUIRED PERMITS AND APPROVALS HAVE BEEN OBTAINED FROM ALL REGULATOR AUTHORITIES. 3. THE CONTRACTOR IS RESPONSIBLE FOR DAMAGE TO ANY EXISTING ITEM AND/OR MATERIAL INSIDE OR OUTSIDE THE CONSTRUCTION LIMITS.

4. ALL PAPER DRAWINGS AND PDFS ARE REPRODUCTIONS AND ARE SUBJECT TO DISTORTION.

5. CONTRACTOR SHALL MAINTAIN THE SITE IN A SAFE AND CLEAN MANNER.

6. STAKE LAYOUT PRIOR TO CONSTRUCTION. VERIFY

LOCATIONS WITH LANDSCAPE ARCHITECT OR OWNER.

7. REFER TO SPECIFICATIONS FOR DETAILED SHOP DRAWING/SUBMITTAL PROCEDURES.

8. EROSION CONTROL MEASURES BY CONTRACTOR AS

TRACK NOTES:

1. SHOP DRAWINGS REQUIRED FOR TRACK LAYOUT AND EVENTS IN FULL COLOR FOR OWNER, DESIGNER AND TRACK CONSULTANT APPROVALS.

2. ALL MATERIAL COLORS SHALL BE APPROVED BY THE

3. ALL CONSTRUCTION DEBRIS SHALL BE DISPOSED OF OFF-SITE PROPERLY (SEE CIVIL DEMOLITION PLAN)

4. CONTRACTOR SHALL PROVIDE A SMOOTH TRANSITION BETWEEN THE CONSTRUCTION PROJECT AND THE EXISTING CONDITIONS.

5. CONTRACTOR IS RESPONSIBLE TO ENSURE FINAL TRACK LAYOUT AND EVENTS MEET ALL NFHS RULES.

6. CONTRACTOR MUST FIELD VERIFY ALL QUANTITIES, AS THE BASE INFORMATION IS BUILT OFF OF AS BUILT PDF's AND IS NOT SURVEY QUALITY.

CONSTRUCTION NOTES

- NEW TRACK OVAL WITH CHANNEL DRAIN 8 X 42" LANES AND RADIUS TO MEASURE LINE OF 104.432'. CONSTRUCT PER DETAIL 1/D100.
- (2) CONSTRUCT RADIUS POINT PER DETAIL 2/D100.
- (3) COMMON FINISH LINE 10M FROM PC.
- (4) COMBOXES WITH TWO (2) 2" DIAMETER, SCH 80 PVC CONDUITS. AS PER DETAIL 1/D102
- (5) STARTING LINE.
- HIGH JUMP AREA WITH MOVEABLE LANDING PAD AND NO PAINTED LINES AS PER DETAIL 6/D102
- CONSTRUCT POLE VAULT BOX AS PER DETAILS 5/D100 &
- (8) LONG/TRIPLE JUMP RUNWAY AS PER DETAIL 7/D100
- NEW SAND PIT AS PER DETAILS 8/D100 & 9/D100
- FIVE PAINTED TAKEOFF LINES PER SANDPIT AT 8', 12', 24', 32', & 36'. TRIPLE JUMP WILL HAVE PAINTED LINES. DETAIL 8/D100
- (11) CONCRETE CURB AT OUTSIDE OF OVAL AS PER DETAIL 3/D100
- 4' H.T. CHAIN LINK FENCE AS PER DETAIL 3/D102
- 4' H.T. CHAIN LINK FENCE WILL TIE INTO EXISTING FENCE IN WOOD LINE
- 4' H.T. CHAIN LINK SINGLE GATE 4' CLEAR WIDTH AS PER DETAIL 4' H.I. CHAIN LINK SINGLE GATE - 4" CLEAR WIDTH AS PER D 4/D102. GATES WILL BE REPLACED IN EXISTING LOCATION.
- 4' H.T. CHAIN LINK DOUBLE GATE 10' CLEAR WIDTH AS PER DETAIL 5/D102.
 GATES WILL BE REPLACED IN EXISTING LOCATION. GATES WILL BE REPLACED IN EXISTING LOCATION.
- 4' H.T. CHAIN LINK DOUBLE GATE 12' CLEAR AS PER DETAIL 5/D102. GATES WILL BE REPLACED IN EXISTING LOCATION. 5/D102. GATES WILL BE REPLACED IN EXISTING LOCATION.
- RESOD ALL DISTRUBED PLAYING FIELD AREAS AFTER TRENCH DRAIN INSTALLATION
- (18) CONSTRUCT POLE VAULT RUNWAY AS PER DETAIL 4/D100.
- CONTRACTOR TO RELOCATE PLAY CLOCK 15' FROM END LINE. COORDINATE WITH LOCATION WITH THE OWNER
- WATER VALVE AND LINE
 BEHIND LJ/TJ RUNWAY WATER VALVE AND LINE TO BE RELOCATED

<u>LEGEND</u>



PROPOSED TRACK SURFACE



PROPOSED CONCRETE



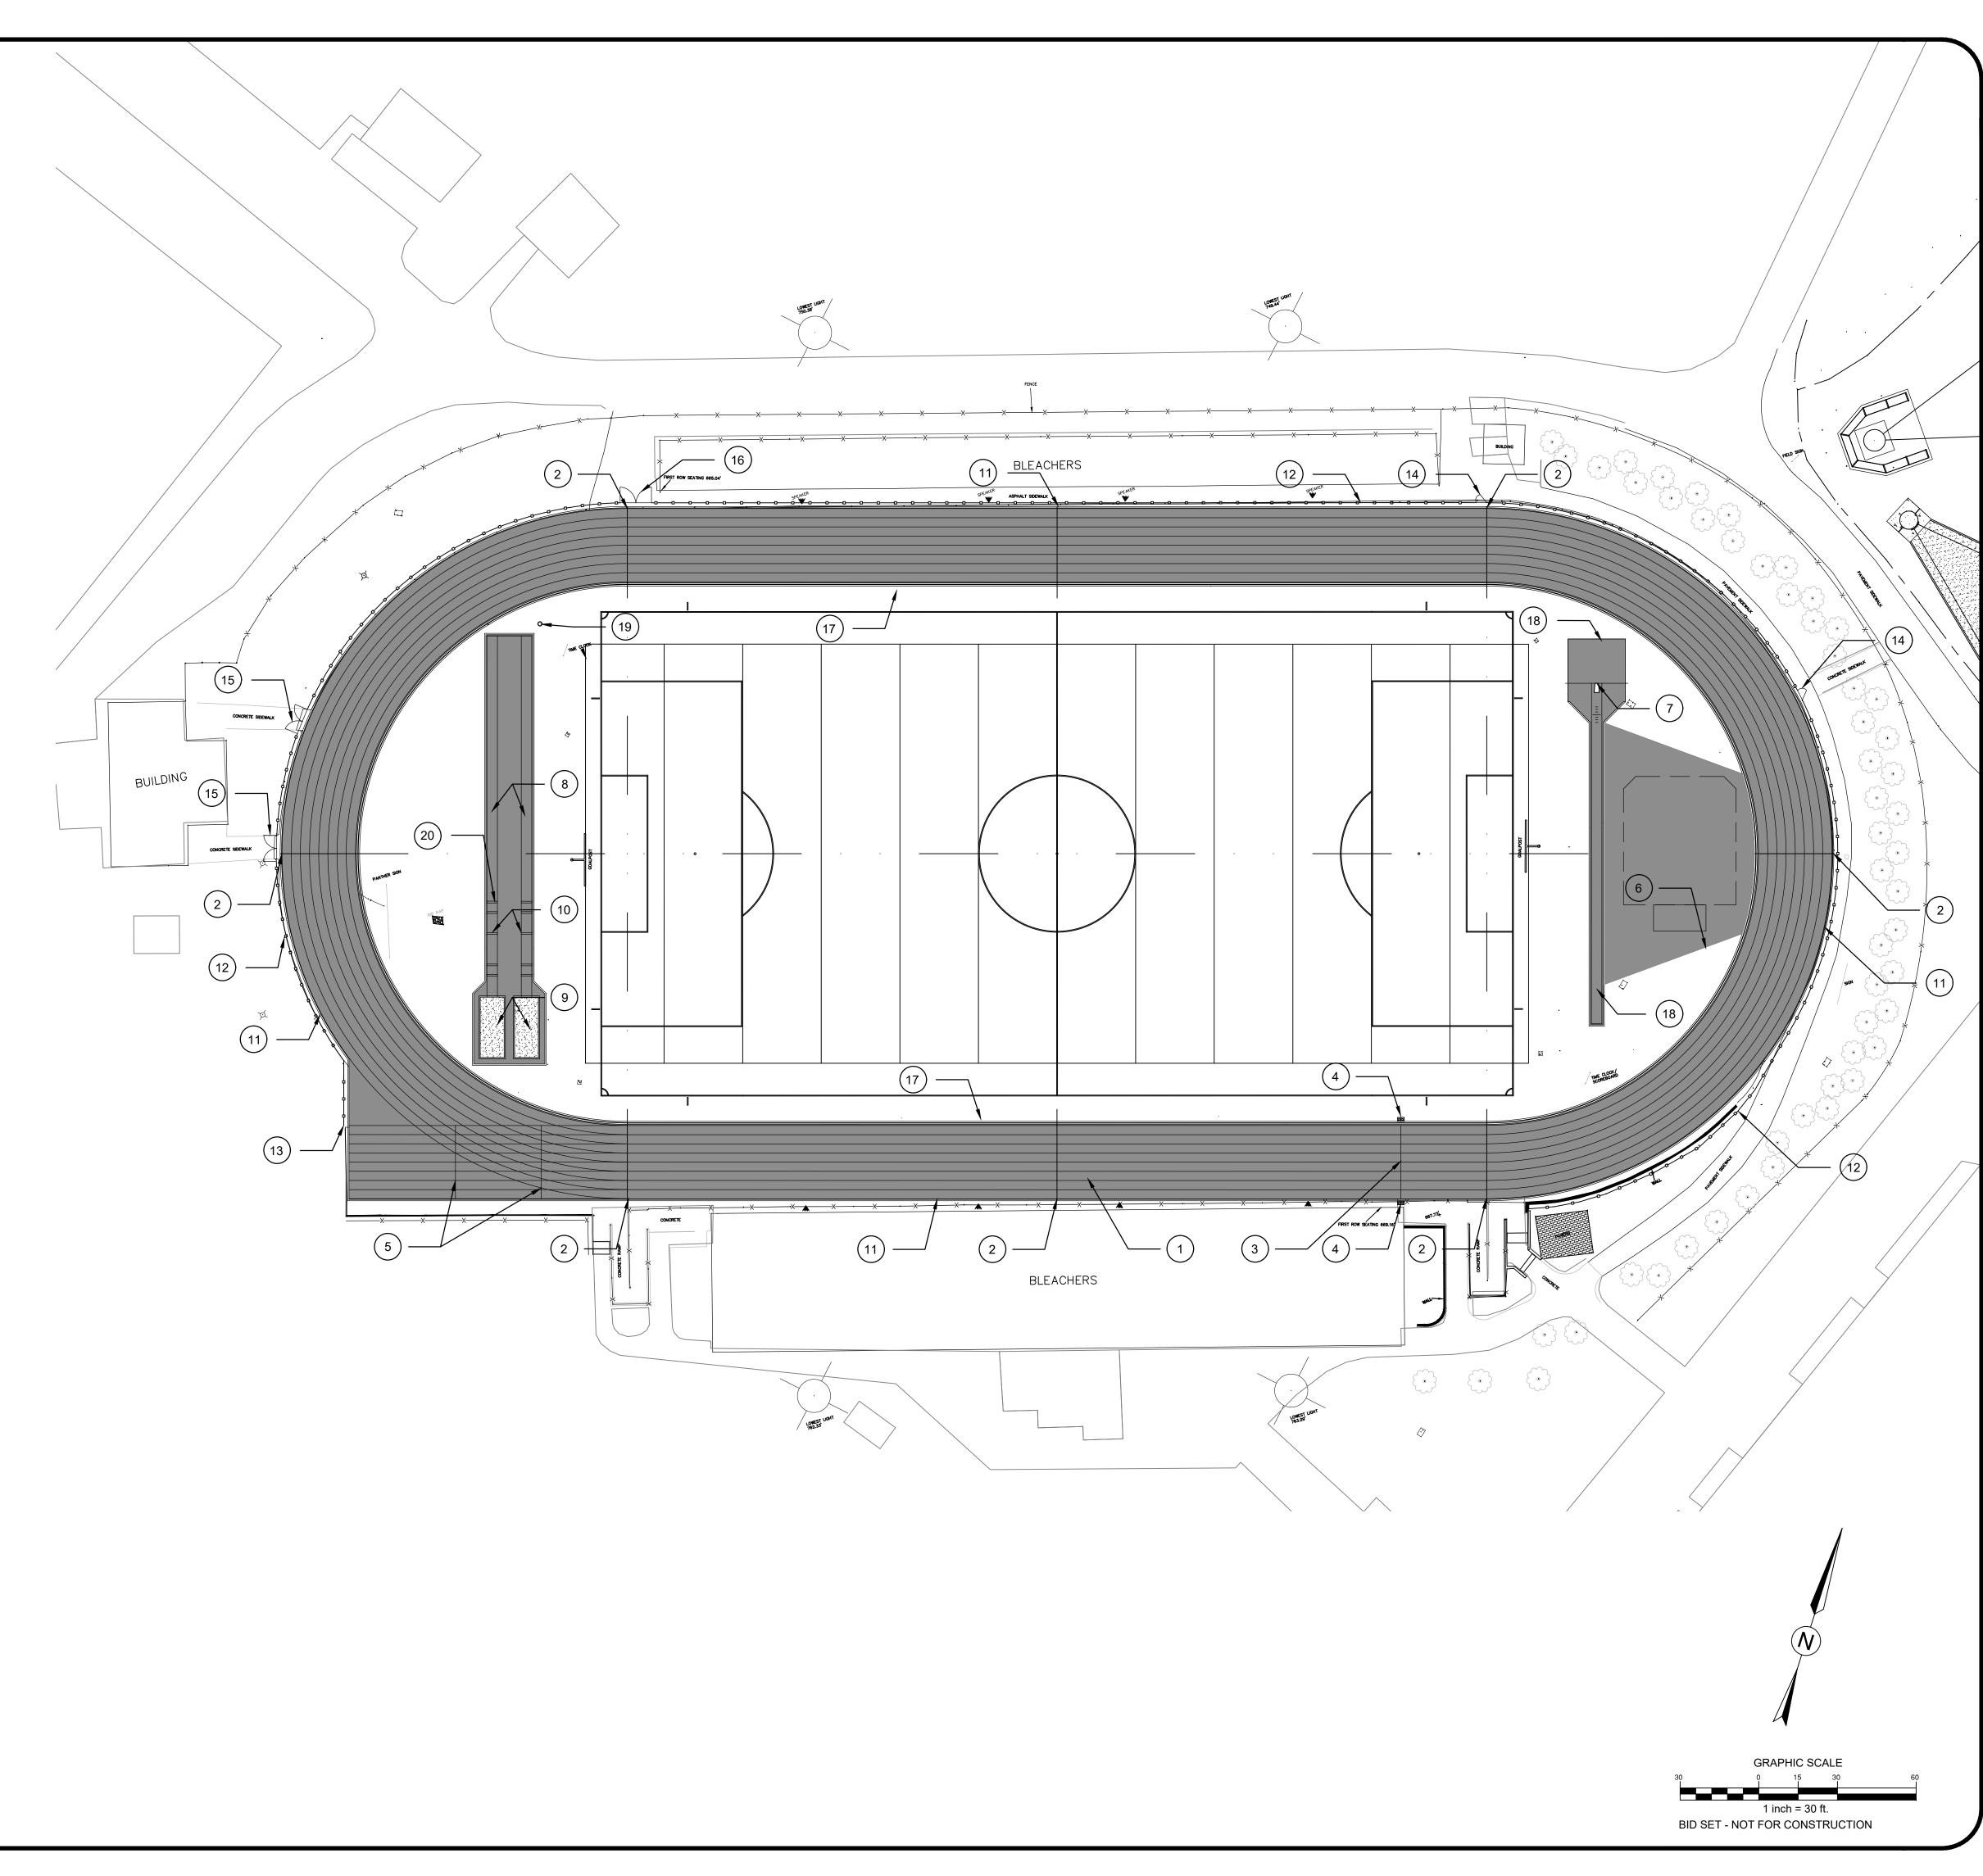
PROPOSED SAND

------ PROPOSED CHAIN LINK FENCE



CONTRACTOR SHALL NOTIFY "NORTH CAROLINA ONE CALL" (811) OR (1-800-632-4949) AT LEAST 48 HOURS PRIOR TO BEGINNING CONSTRUCTION OR EXCAVATION TO HAVE EXISTING UTILITIES LOCATED. CONTRACTOR SHALL CONTACT ANY LOCAL UTILITIES THAT PROVIDE THEIR OWN LOCATOR SERVICES INDEPENDENT OF "NORTH CAROLINA ONE CALL".

REPORT ANY DISCREPANCIES TO THE ENGINEER IMMEDIATELY.






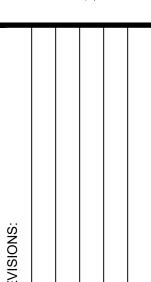314 TOM HALL ST. FORT MILL, SC 803.981.4330







SCALE: 1" = 30'-0"

DATE: 3-12-25

SHEET NAME: **OVAL LAYOUT**

SHEET NO:

PLAN

LAYOUT NOTES

1. SHOULD ANY DISCREPANCIES BE FOUND IN THE FIELD THE CONTRACTOR SHALL CONTACT THE OWNER AND LANDSCAPE ARCHITECT/SPORT FIELD DESIGNER PRIOR TO PROCEEDING.

2. PRIOR TO BEGINNING CONSTRUCTION, THE CONTRACTOR SHALL BE RESPONSIBLE FOR VERIFYING THAT ALL REQUIRED PERMITS AND APPROVALS HAVE BEEN OBTAINED FROM ALL REGULATOR AUTHORITIES.

3. THE CONTRACTOR IS RESPONSIBLE FOR DAMAGE TO ANY EXISTING ITEM AND/OR MATERIAL INSIDE OR OUTSIDE THE CONSTRUCTION LIMITS.

4. ALL PAPER DRAWINGS AND PDFS ARE REPRODUCTIONS AND ARE SUBJECT TO DISTORTION.

5. CONTRACTOR SHALL MAINTAIN THE SITE IN A SAFE AND CLEAN MANNER.

6. STAKE LAYOUT PRIOR TO CONSTRUCTION. VERIFY LOCATIONS WITH LANDSCAPE ARCHITECT OR OWNER.

7. REFER TO SPECIFICATIONS FOR DETAILED SHOP DRAWING/SUBMITTAL PROCEDURES.

8. EROSION CONTROL MEASURES BY CONTRACTOR AS

TRACK NOTES:

1. SHOP DRAWINGS REQUIRED FOR TRACK LAYOUT AND EVENTS IN FULL COLOR FOR OWNER, DESIGNER AND TRACK CONSULTANT APPROVALS.

2. ALL MATERIAL COLORS SHALL BE APPROVED BY THE

3. ALL CONSTRUCTION DEBRIS SHALL BE DISPOSED OF OFF-SITE PROPERLY (SEE CIVIL DEMOLITION PLAN)

4. CONTRACTOR SHALL PROVIDE A SMOOTH TRANSITION BETWEEN THE CONSTRUCTION PROJECT AND THE EXISTING CONDITIONS.

5. CONTRACTOR IS RESPONSIBLE TO ENSURE FINAL TRACK LAYOUT AND EVENTS MEET ALL NFHS RULES.

6. CONTRACTOR MUST FIELD VERIFY ALL QUANTITIES, AS THE BASE INFORMATION IS BUILT OFF OF AS BUILT PDF's AND IS NOT SURVEY QUALITY.

CONSTRUCTION NOTES

21) SHOT PUT LANDING AREA AS PER DETAIL 5/D101 & 6/D101

CONSTRUCT THROW CIRCLE AS PER DETAILS 3/D101. DISCUS AND SHOT PUT LOCATION TBD DURING CONSTRUCTION

(23) CONSTRUCT DISCUS CAGE AS PER DETAILS 4/D101



PROPOSED TRACK SURFACE



PROPOSED CONCRETE



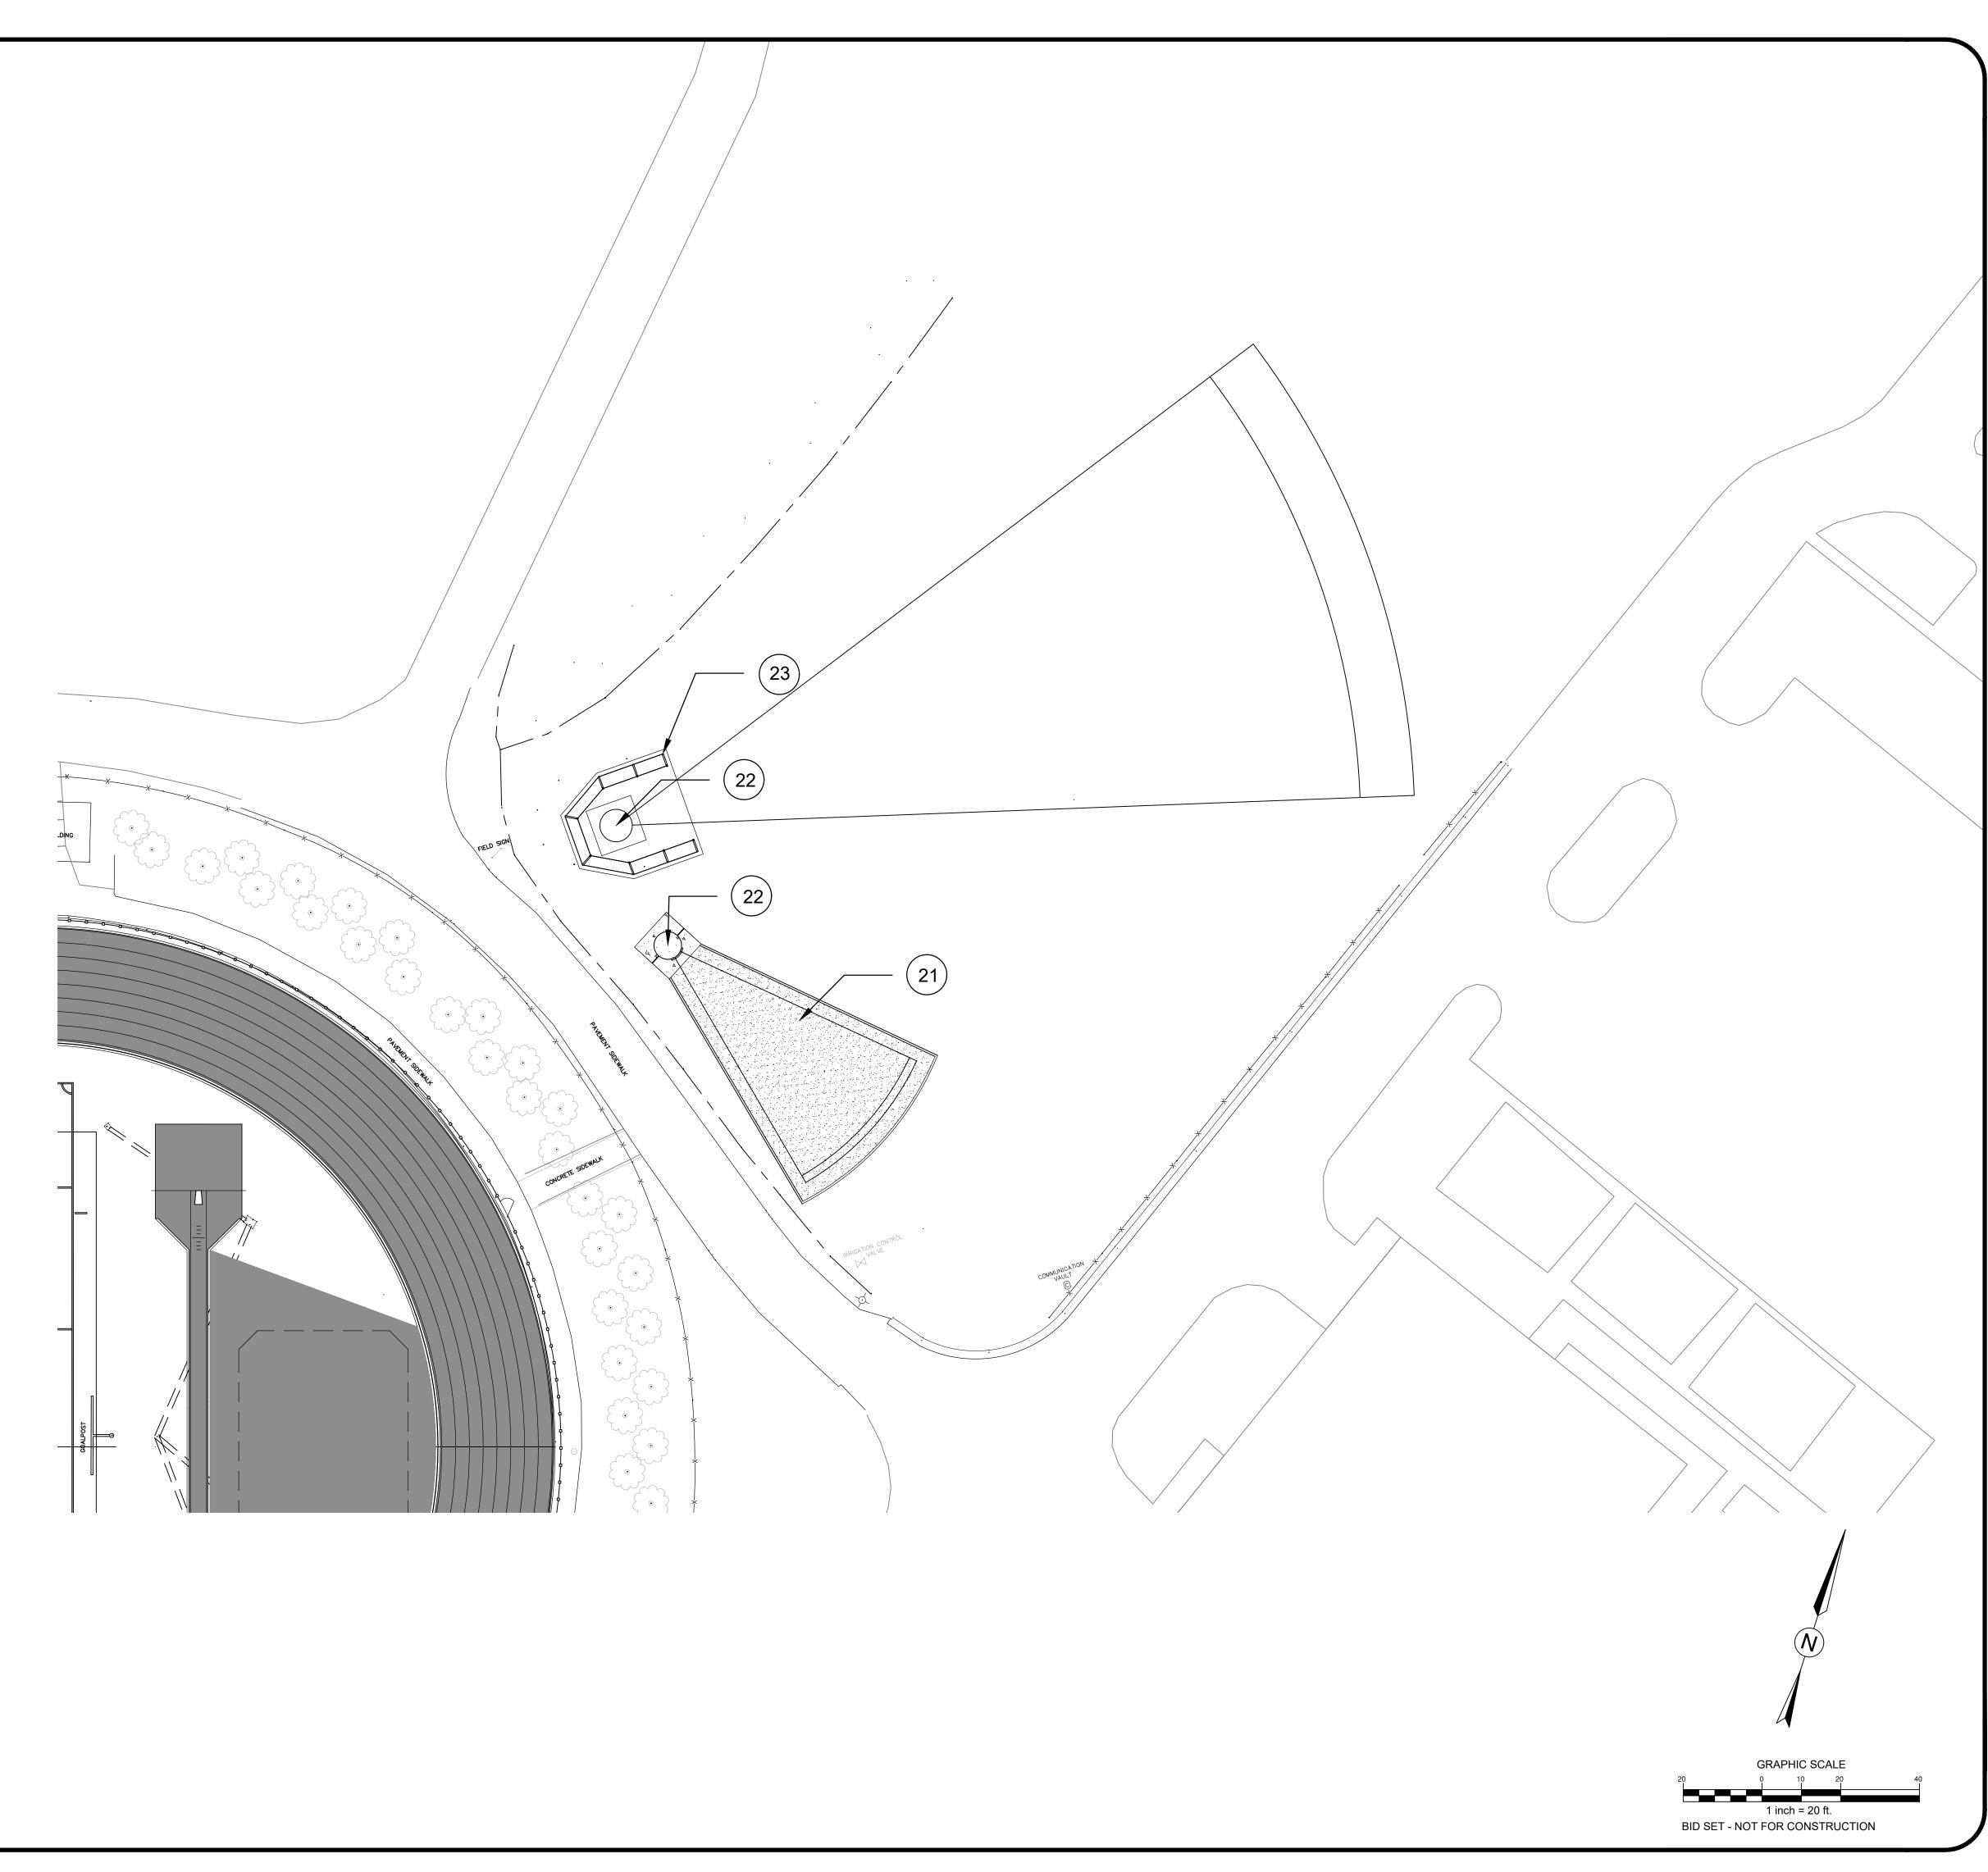
PROPOSED SAND

------ PROPOSED CHAIN LINK FENCE



CONTRACTOR SHALL NOTIFY "NORTH CAROLINA ONE CALL" (811) OR (1-800-632-4949) AT LEAST 48 HOURS PRIOR TO BEGINNING CONSTRUCTION OR EXCAVATION TO HAVE EXISTING UTILITIES LOCATED. CONTRACTOR SHALL CONTACT ANY LOCAL UTILITIES THAT PROVIDE THEIR OWN LOCATOR SERVICES INDEPENDENT OF "NORTH CAROLINA ONE CALL".

EPORT ANY DISCREPANCIES TO THE ENGINEER IMMEDIATELY.






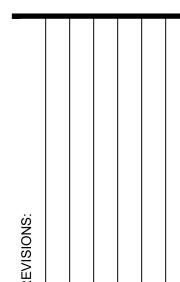314 TOM HALL ST. FORT MILL, SC 803.981.4330







SCALE: 1" = 20'-0" DATE: 3-12-25

SHEET NAME: THROWING EVENTS LAYOUT PLAN

LAYOUT NOTES

- 1. SHOULD ANY DISCREPANCIES BE FOUND IN THE FIELD THE CONTRACTOR SHALL CONTACT THE OWNER AND LANDSCAPE ARCHITECT/SPORT FIELD DESIGNER PRIOR TO PROCEEDING.
- 2. PRIOR TO BEGINNING CONSTRUCTION, THE CONTRACTOR SHALL BE RESPONSIBLE FOR VERIFYING THAT ALL REQUIRED PERMITS AND APPROVALS HAVE BEEN OBTAINED FROM ALL REGULATOR AUTHORITIES.
- 3. THE CONTRACTOR IS RESPONSIBLE FOR DAMAGE TO ANY EXISTING ITEM AND/OR MATERIAL INSIDE OR OUTSIDE THE CONSTRUCTION LIMITS.
- 4. ALL PAPER DRAWINGS AND PDFS ARE REPRODUCTIONS AND ARE SUBJECT TO DISTORTION.
- 5. CONTRACTOR SHALL MAINTAIN THE SITE IN A SAFE AND CLEAN MANNER.
- 6. STAKE LAYOUT PRIOR TO CONSTRUCTION. VERIFY LOCATIONS WITH LANDSCAPE ARCHITECT OR OWNER.
- 7. REFER TO SPECIFICATIONS FOR DETAILED SHOP
- DRAWING/SUBMITTAL PROCEDURES.
- 8. EROSION CONTROL MEASURES BY CONTRACTOR AS NEEDED.

DIMENSION NOTES:

- 1. ALL DIMENSIONS ARE IN DECIMAL FEET.
- 2. LONG/TRIPLE JUMP SAND PIT DIMENSIONS ARE TO THE CENTER LEADING EDGE OF THE PIT SAND AS PER DETAILS 8/D100
- 3. POLE VAULT BOX DIMENSIONS ARE TO CENTER OF BACK EDGE OF THE VAULT BOX AS PER DETAIL 6/D100.
- 4. RADIUS POINT DIMENSIONS ARE TO CENTER OF THE
- 5. ALL OTHER DIMENSIONS ARE TO FACE OF CONCRETE.
- 6. REFER TO TRACK LAYOUT PLAN FOR PROPOSED SURFACES AND ADDITIONAL CALL OUTS.
- 7. THE COMM. BOX LOCATED OUTSIDE THE TRACK OVAL IS ADJACENT TO THE OUTSIDE CONCRETE CURB AND THE COMM. BOX INSIDE THE TRACK OVAL IS ADJACENT TO THE CHANNEL DRAIN OR CONCRETE CURB.



PROPOSED TRACK SURFACE

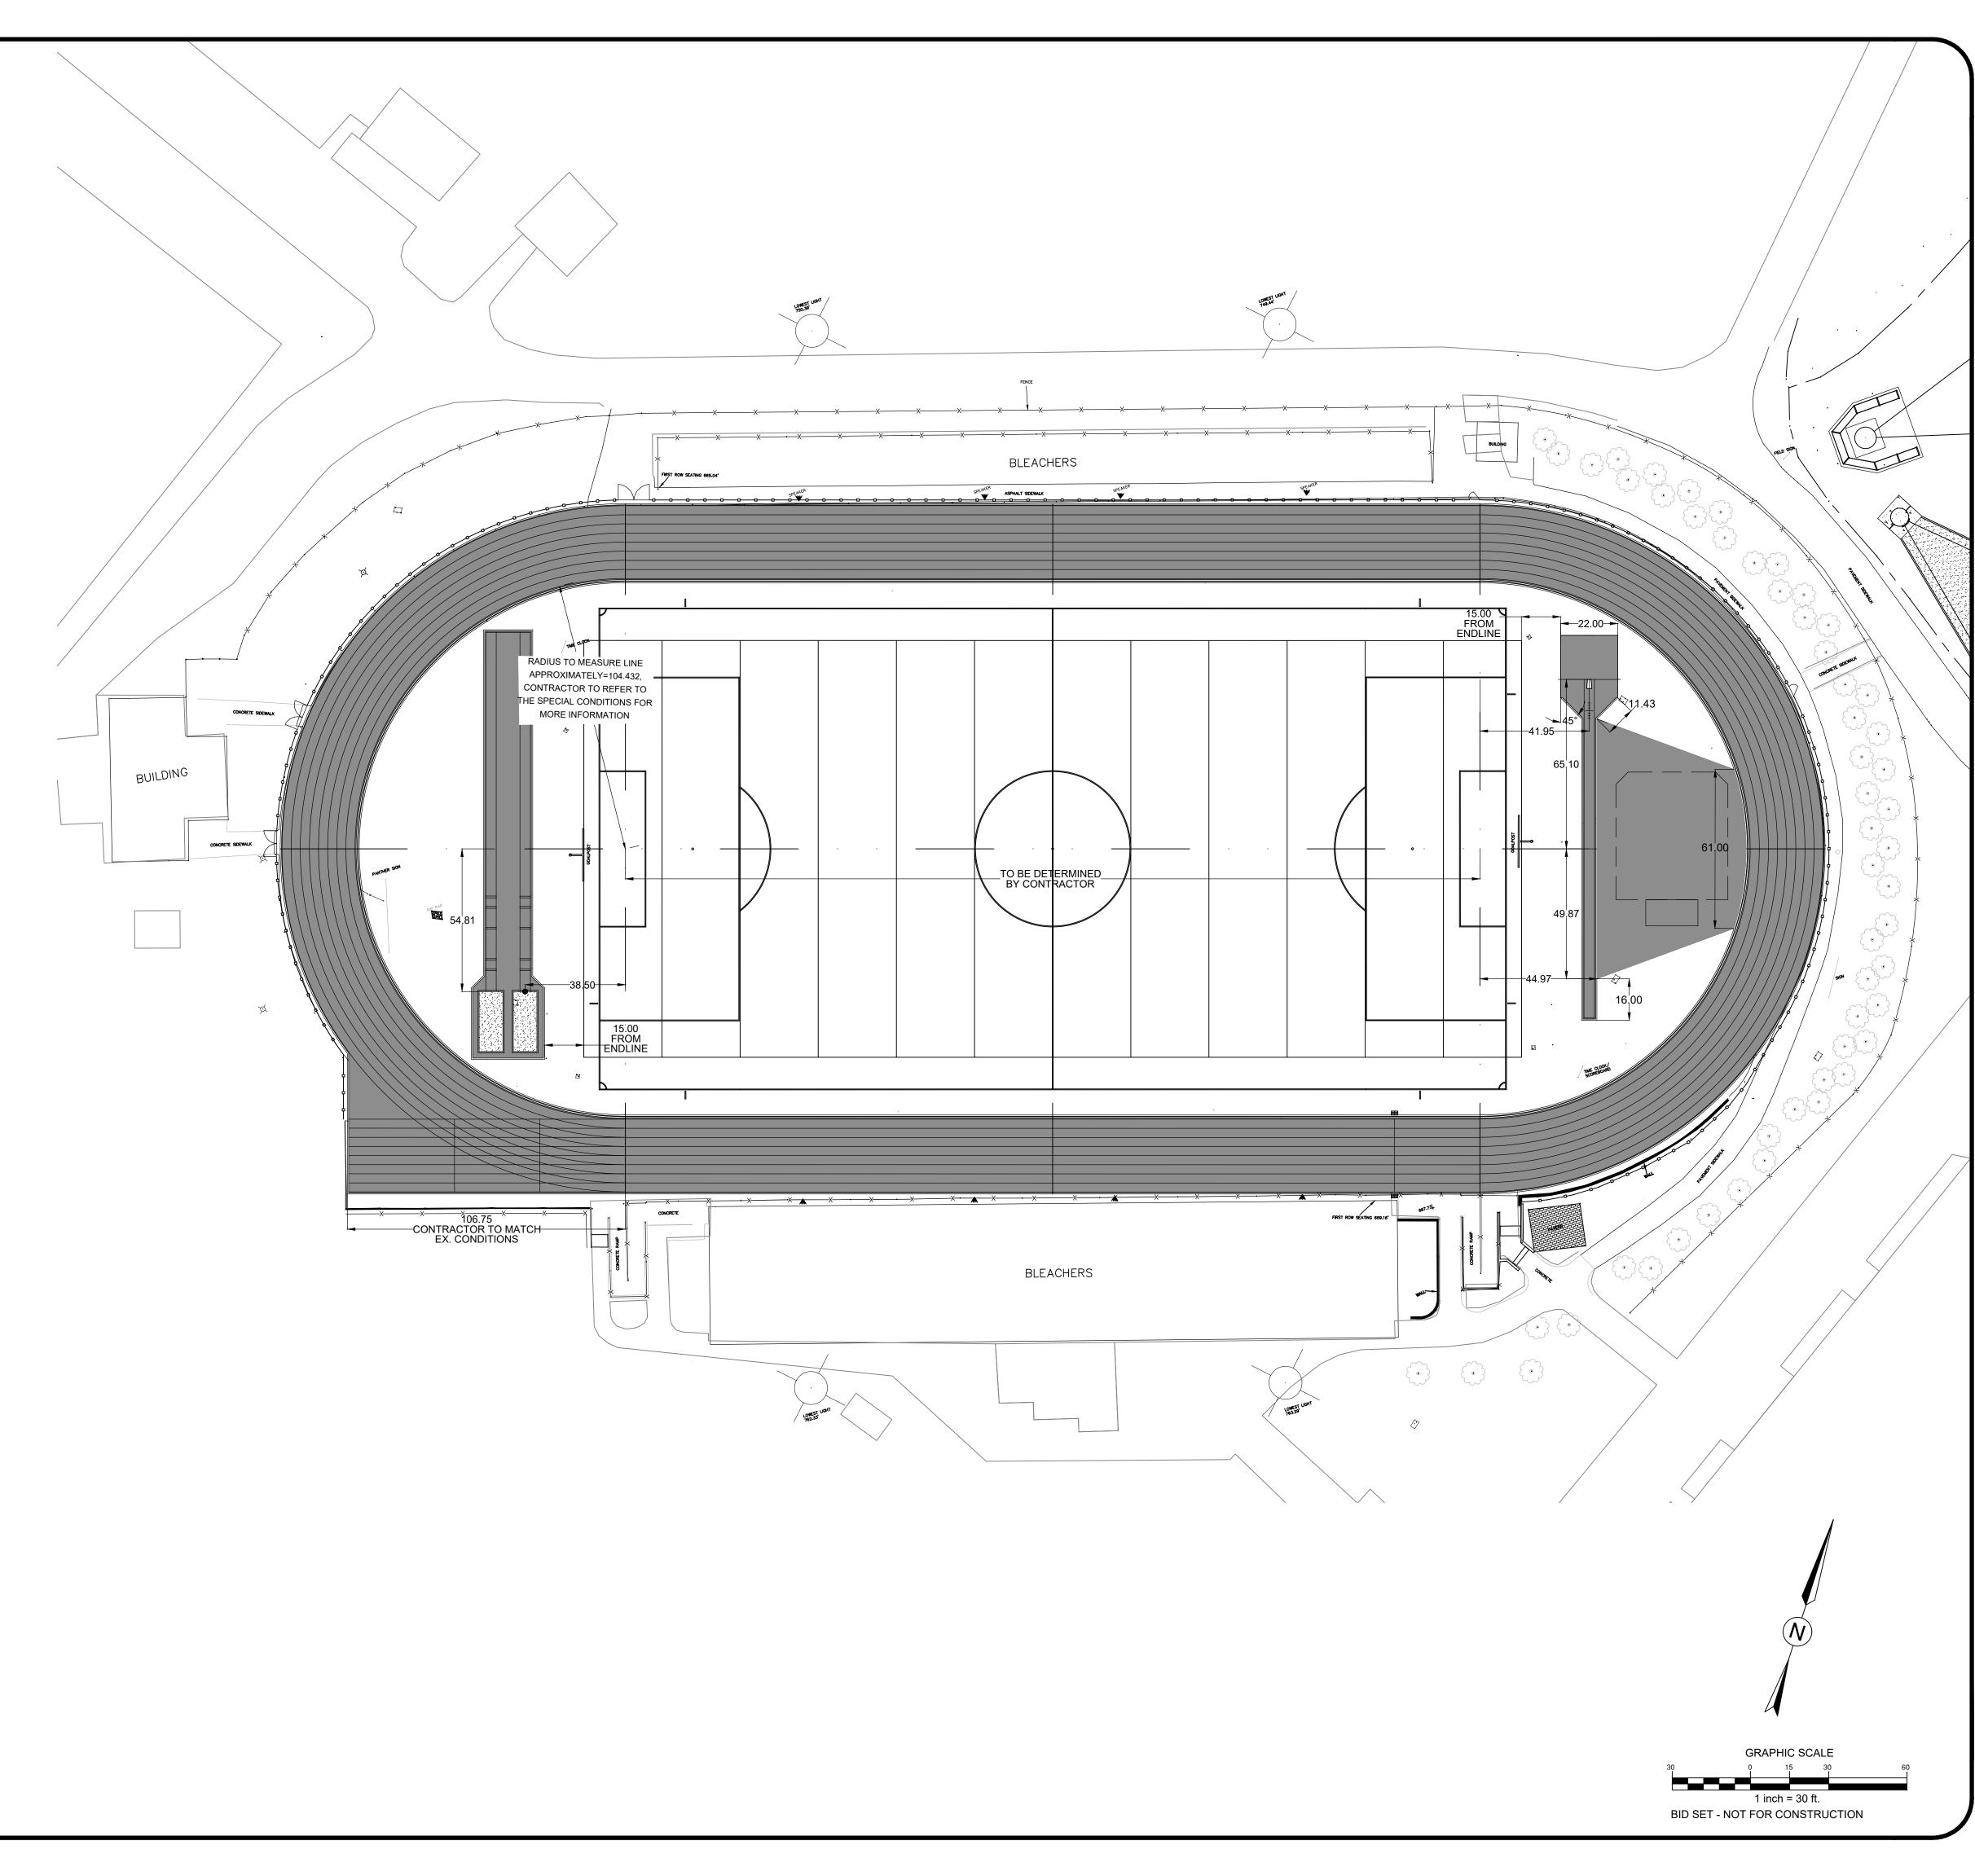


PROPOSED SAND

PROPOSED CONCRETE

Taking Astronomic


------ PROPOSED CHAIN LINK FENCE






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RLOTTE MECKLENBURG
OARD OF EDUCATION
POST OFFICE BOX 30035
CHARLOTTE NC 28230

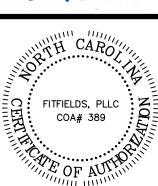OWNER:

CHARLOTTE

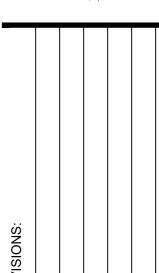BOARD O

DENCE HIGH SCHOOL
CK RENOVATIONS
PINEVILLE-MATTHEWS ROAD

SCALE: 1" = 30'-0"

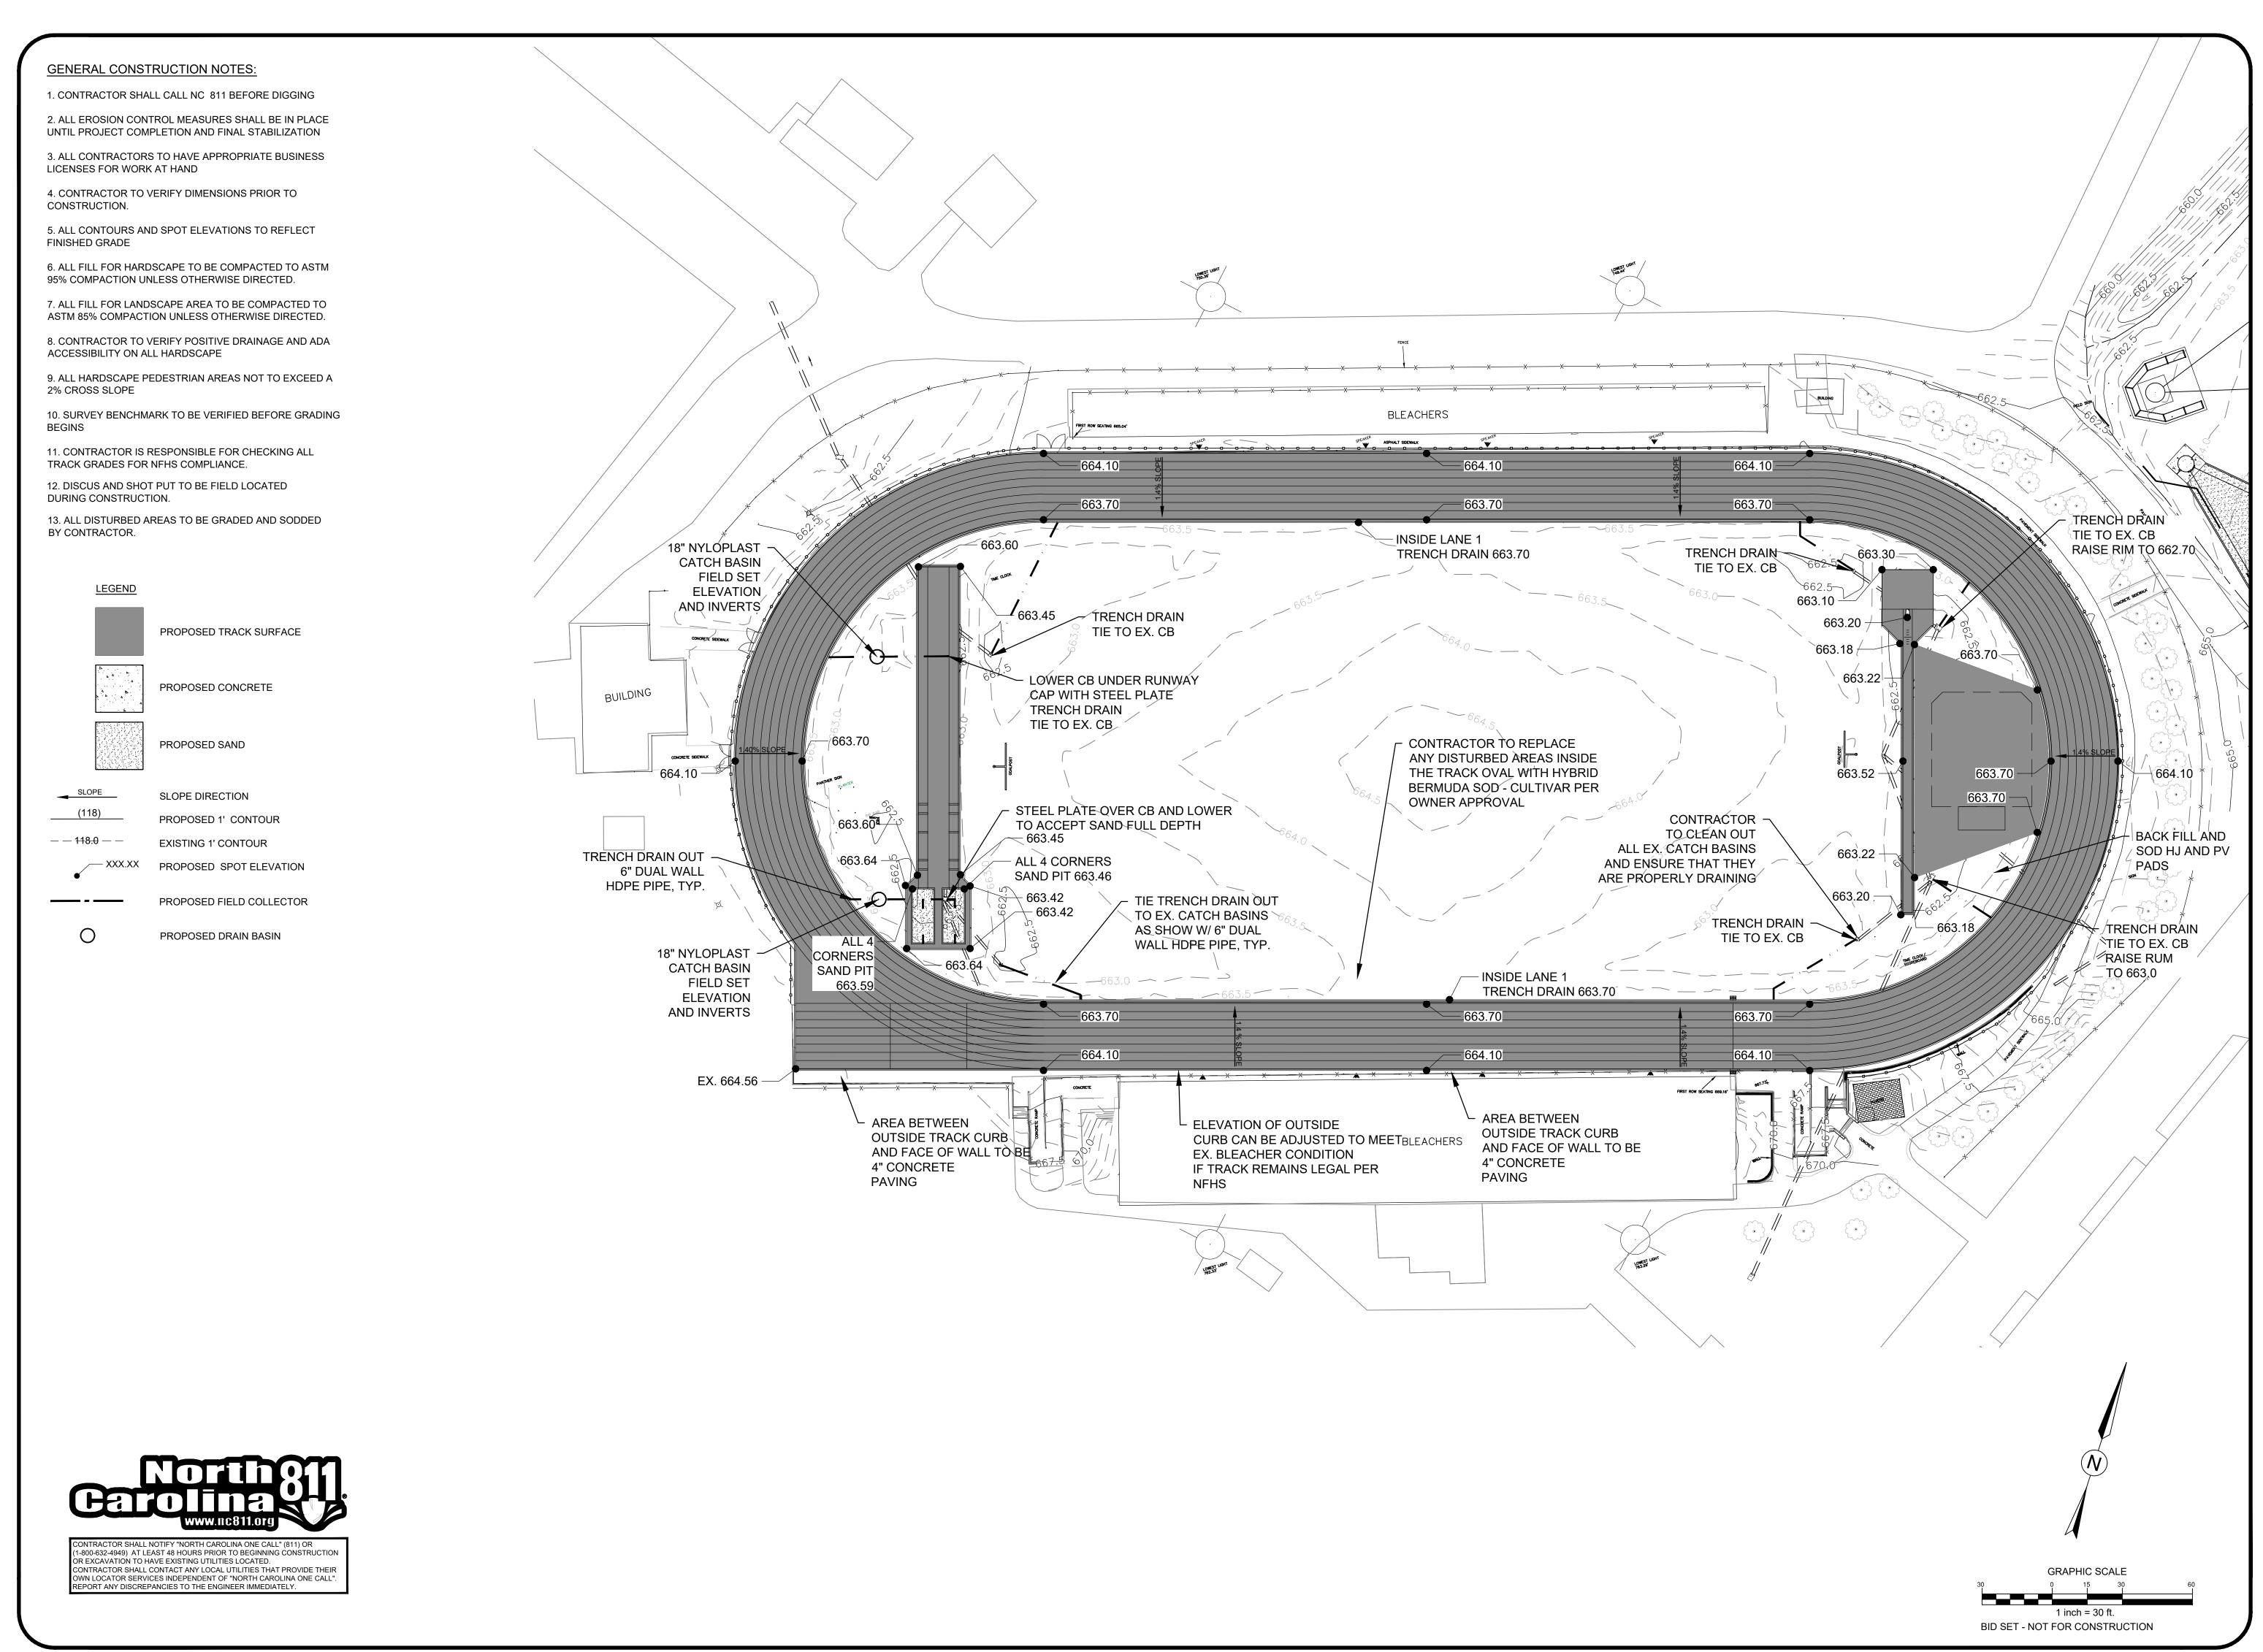
DATE: 3-12-25

SHEET NAME:

DIMENSION PLAN


SHEET NO:


CONTRACTOR SHALL NOTIFY "NORTH CAROLINA ONE CALL" (811) OR (1-800-632-4949) AT LEAST 48 HOURS PRIOR TO BEGINNING CONSTRUCTION OR EXCAVATION TO HAVE EXISTING UTILITIES LOCATED. CONTRACTOR SHALL CONTACT ANY LOCAL UTILITIES THAT PROVIDE THEIR OWN LOCATOR SERVICES INDEPENDENT OF "NORTH CAROLINA ONE CALL". REPORT ANY DISCREPANCIES TO THE ENGINEER IMMEDIATELY.



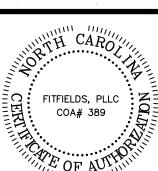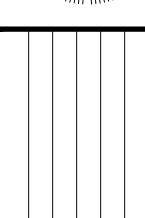314 TOM HALL ST. FORT MILL, SC 803.981.4330







SCALE: 1" = 30'-0" DATE: 3-12-25

SHEET NAME: **OVAL GRADING AND**

DRAINAGE PLAN

GENERAL CONSTRUCTION NOTES:

1. CONTRACTOR SHALL CALL NC 811 BEFORE DIGGING

2. ALL EROSION CONTROL MEASURES SHALL BE IN PLACE UNTIL PROJECT COMPLETION AND FINAL STABILIZATION

3. ALL CONTRACTORS TO HAVE APPROPRIATE BUSINESS LICENSES FOR WORK AT HAND

4. CONTRACTOR TO VERIFY DIMENSIONS PRIOR TO CONSTRUCTION.

5. ALL CONTOURS AND SPOT ELEVATIONS TO REFLECT FINISHED GRADE

6. ALL FILL FOR HARDSCAPE TO BE COMPACTED TO ASTM 95% COMPACTION UNLESS OTHERWISE DIRECTED.

7. ALL FILL FOR LANDSCAPE AREA TO BE COMPACTED TO ASTM 85% COMPACTION UNLESS OTHERWISE DIRECTED.

8. CONTRACTOR TO VERIFY POSITIVE DRAINAGE AND ADA ACCESSIBILITY ON ALL HARDSCAPE

9. ALL HARDSCAPE PEDESTRIAN AREAS NOT TO EXCEED A 2% CROSS SLOPE

10. SURVEY BENCHMARK TO BE VERIFIED BEFORE GRADING **BEGINS**

11. CONTRACTOR IS RESPONSIBLE FOR CHECKING ALL

12. DISCUS AND SHOT PUT TO BE FIELD LOCATED

TRACK GRADES FOR NFHS COMPLIANCE.

DURING CONSTRUCTION.

13. ALL DISTURBED AREAS TO BE GRADED AND SODDED BY CONTRACTOR.

<u>LEGEND</u>



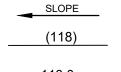
PROPOSED TRACK SURFACE



PROPOSED CONCRETE



PROPOSED SAND




SLOPE DIRECTION

--118.0--

PROPOSED 1' CONTOUR EXISTING 1' CONTOUR

XXX.XX PROPOSED SPOT ELEVATION

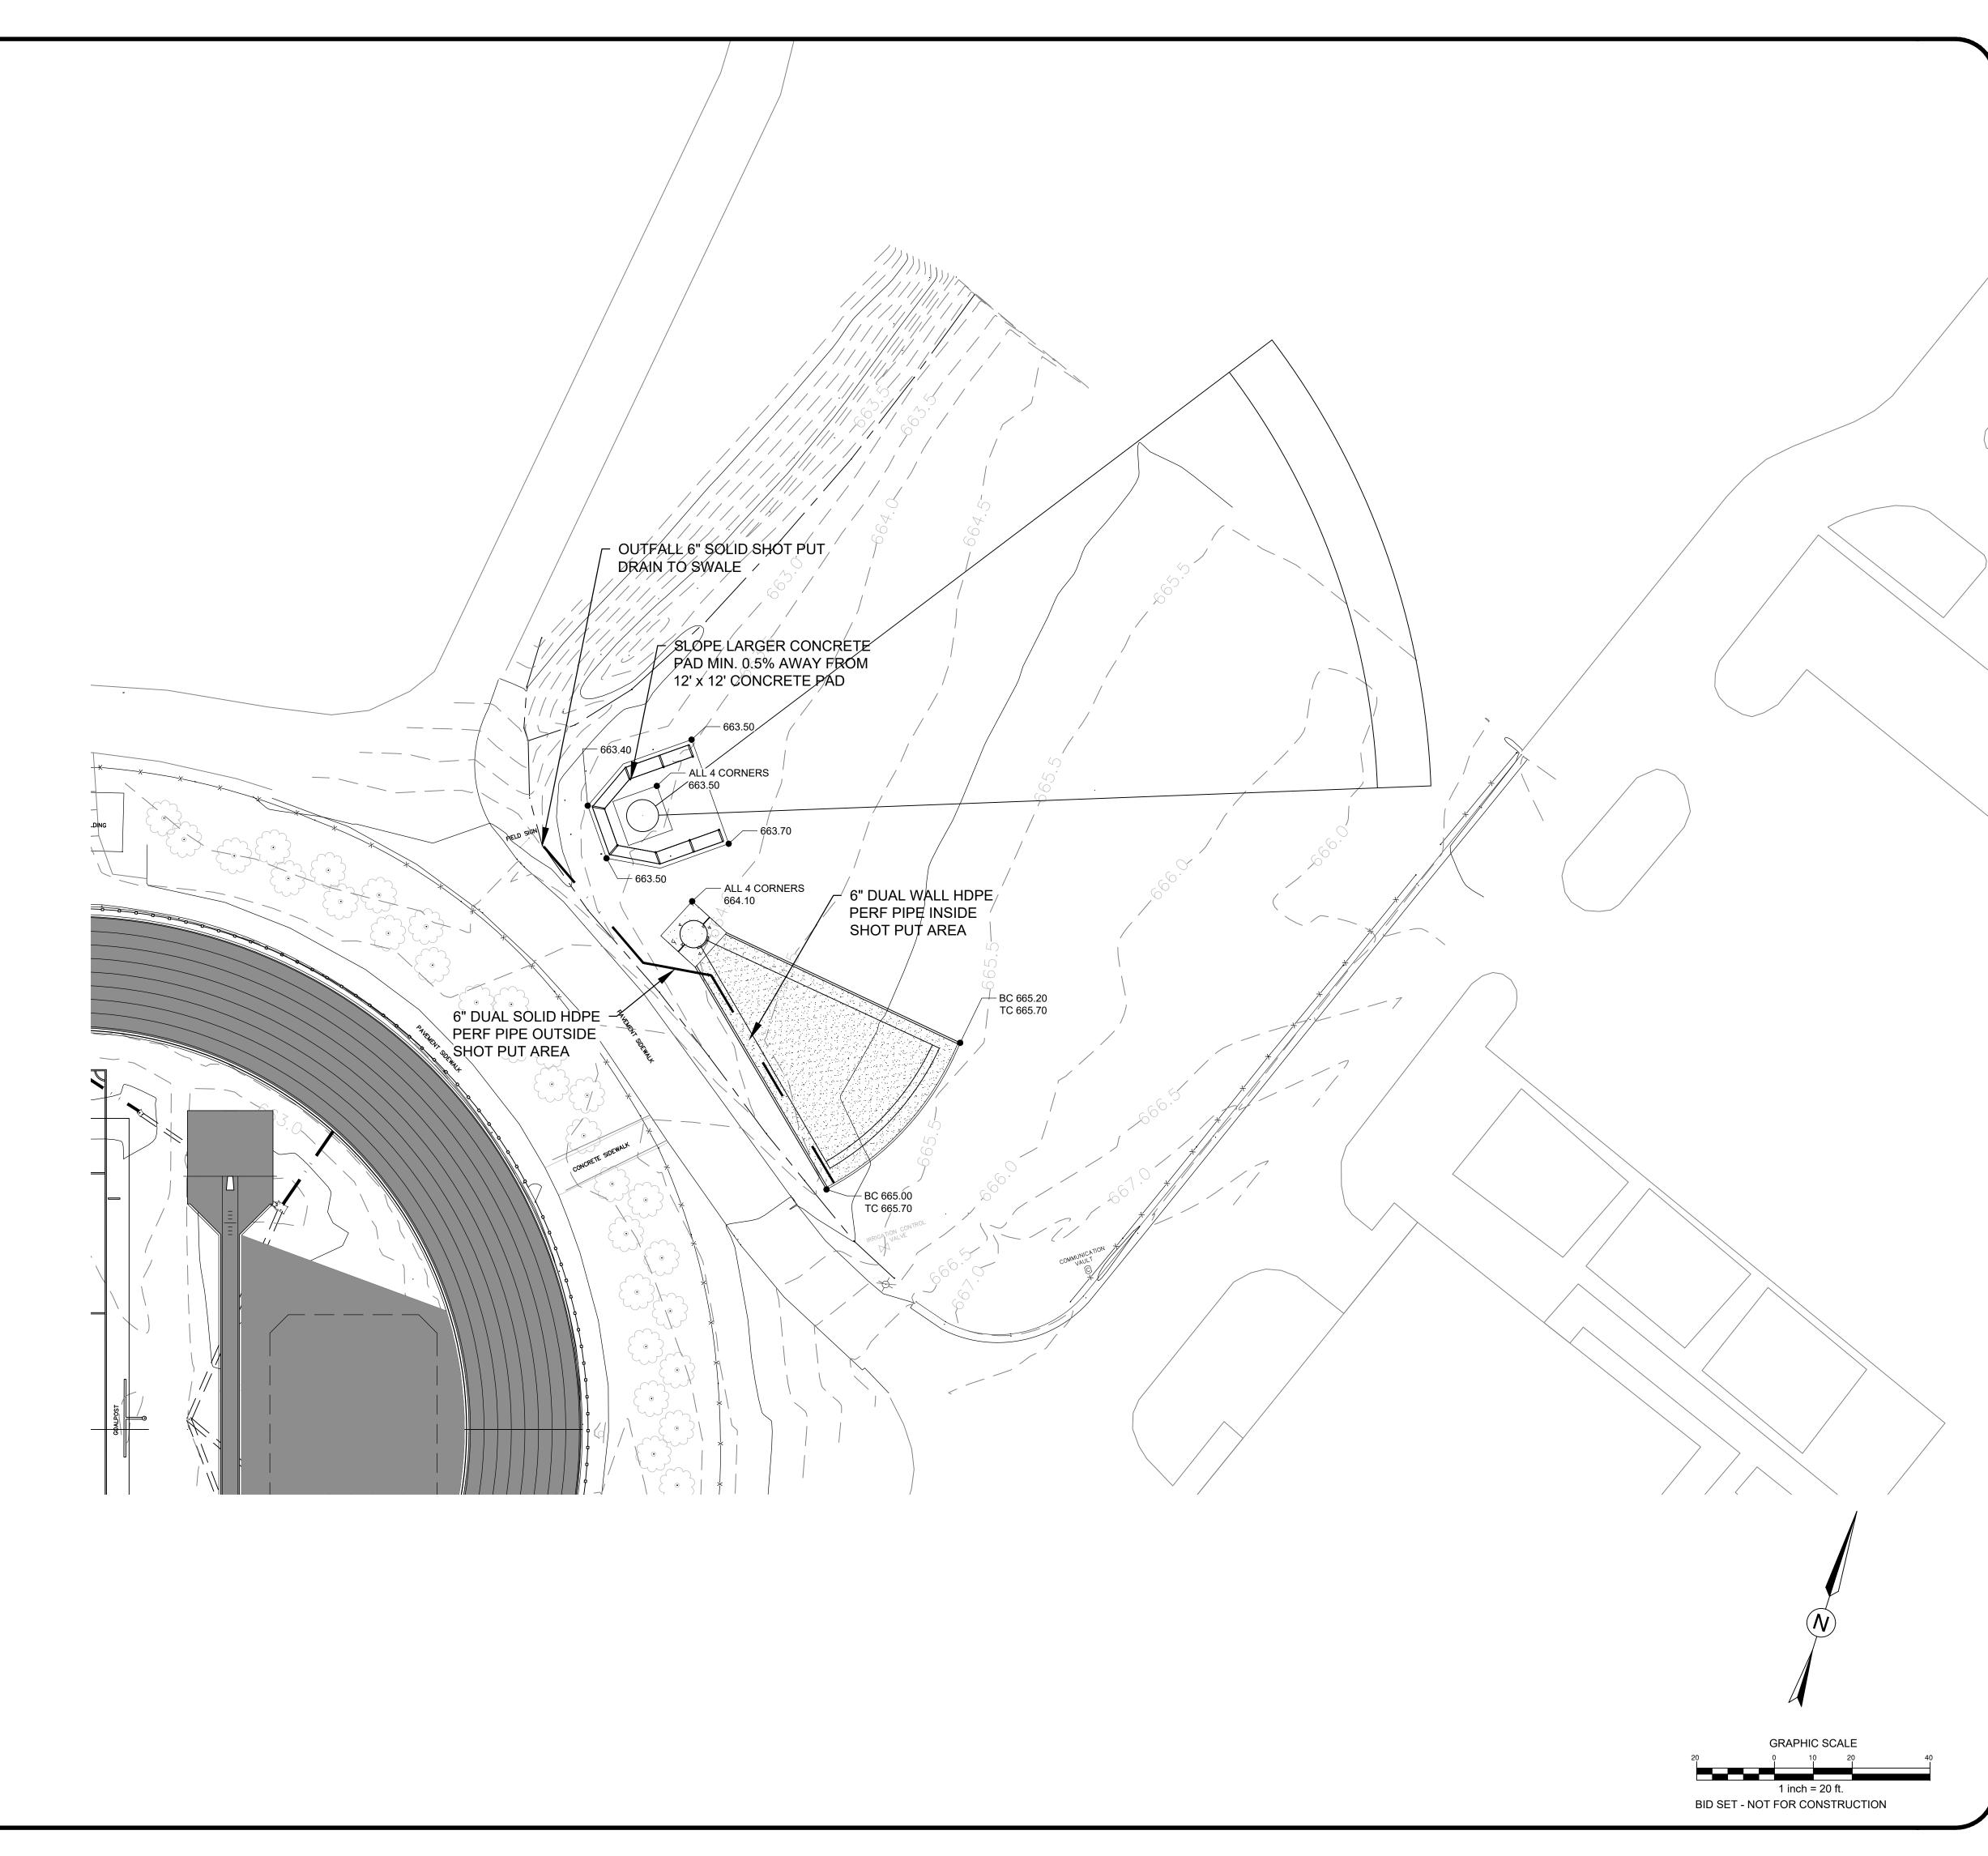PROPOSED FIELD COLLECTOR






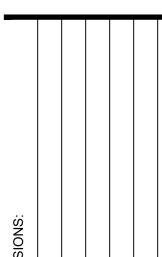314 TOM HALL ST. FORT MILL, SC 803.981.4330







SCALE: 1" = 20'-0"

DATE: 3-12-25

SHEET NAME: THROWING EVENTS

GRADING PLAN

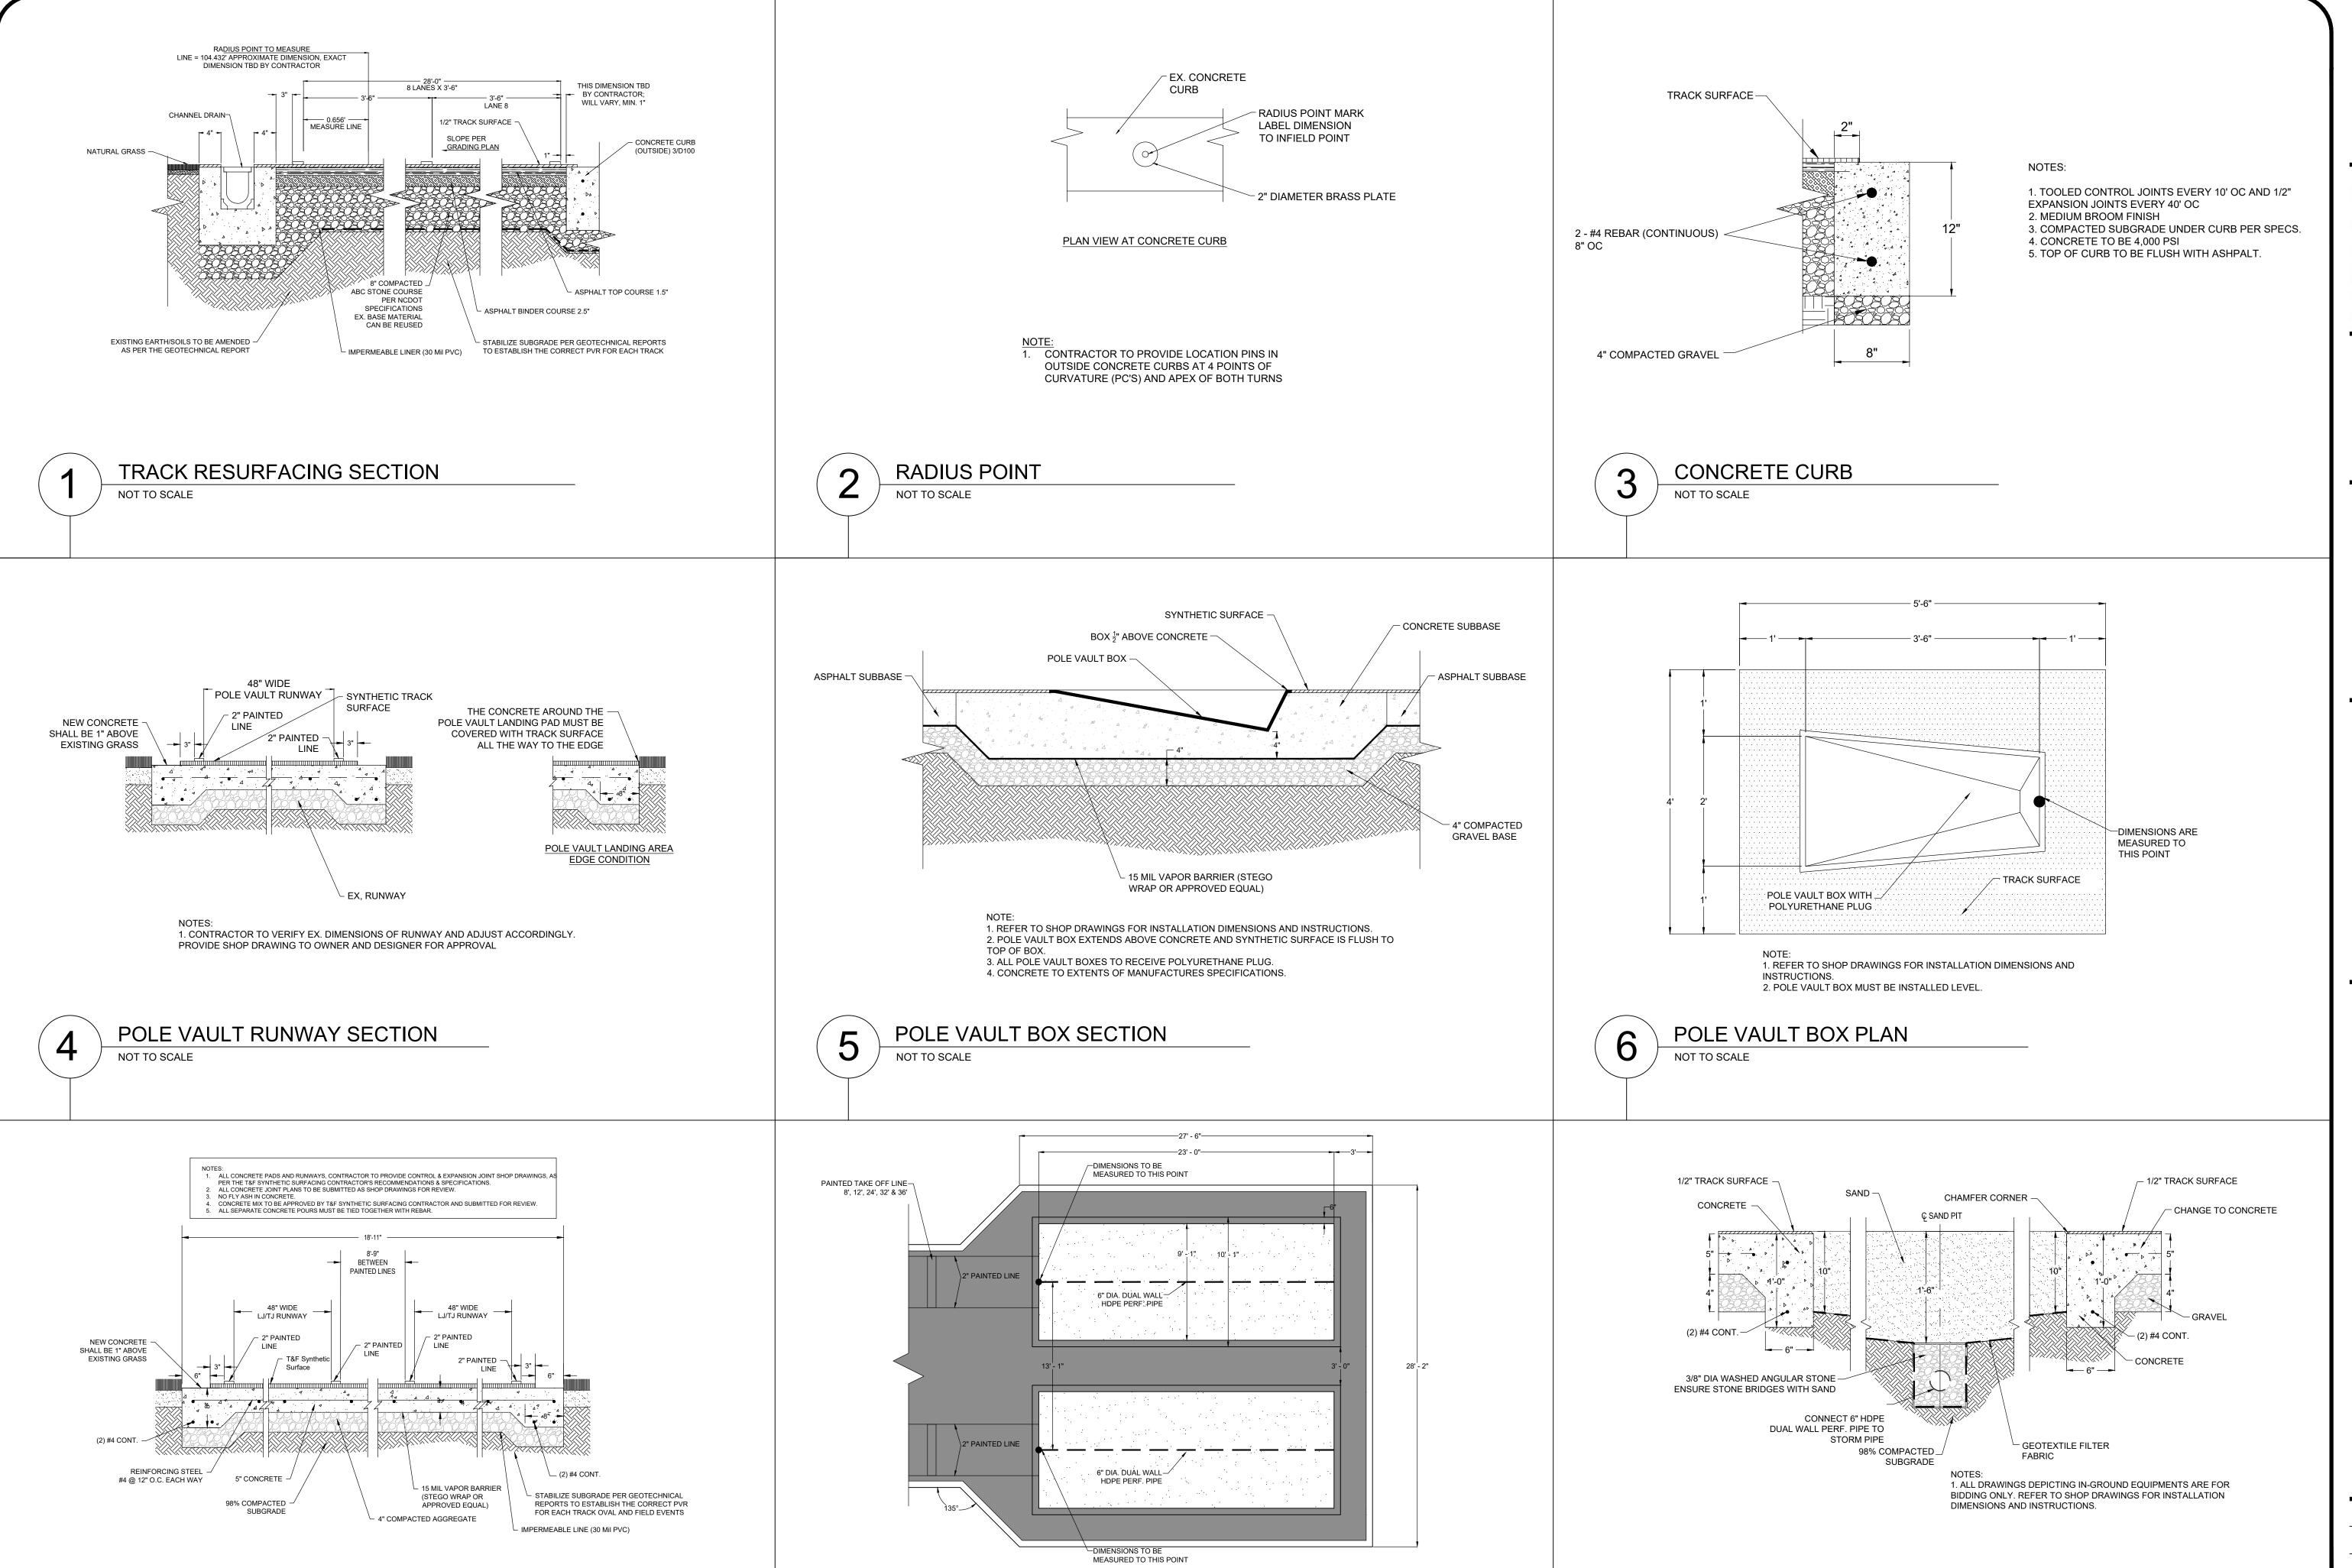
SHEET NO:



CONTRACTOR SHALL CONTACT ANY LOCAL UTILITIES THAT PROVIDE THEIR OWN LOCATOR SERVICES INDEPENDENT OF "NORTH CAROLINA ONE CALL".

EPORT ANY DISCREPANCIES TO THE ENGINEER IMMEDIATELY.

OR EXCAVATION TO HAVE EXISTING UTILITIES LOCATED.



1. FIVE PAINTED TAKEOFF LINES FOR LONG JUMP PER SAND PIT AT 8', 12', 24', 32', & 36'.

TRIPLE JUMP WILL HAVE PAINTED LINES.

SAND PIT PLAN VIEW

NOT TO SCALE

LONG JUMP AND TRIPLE JUMP RUNWAY

FITFIELDS

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SCALE: NTS DATE: 3-12-25

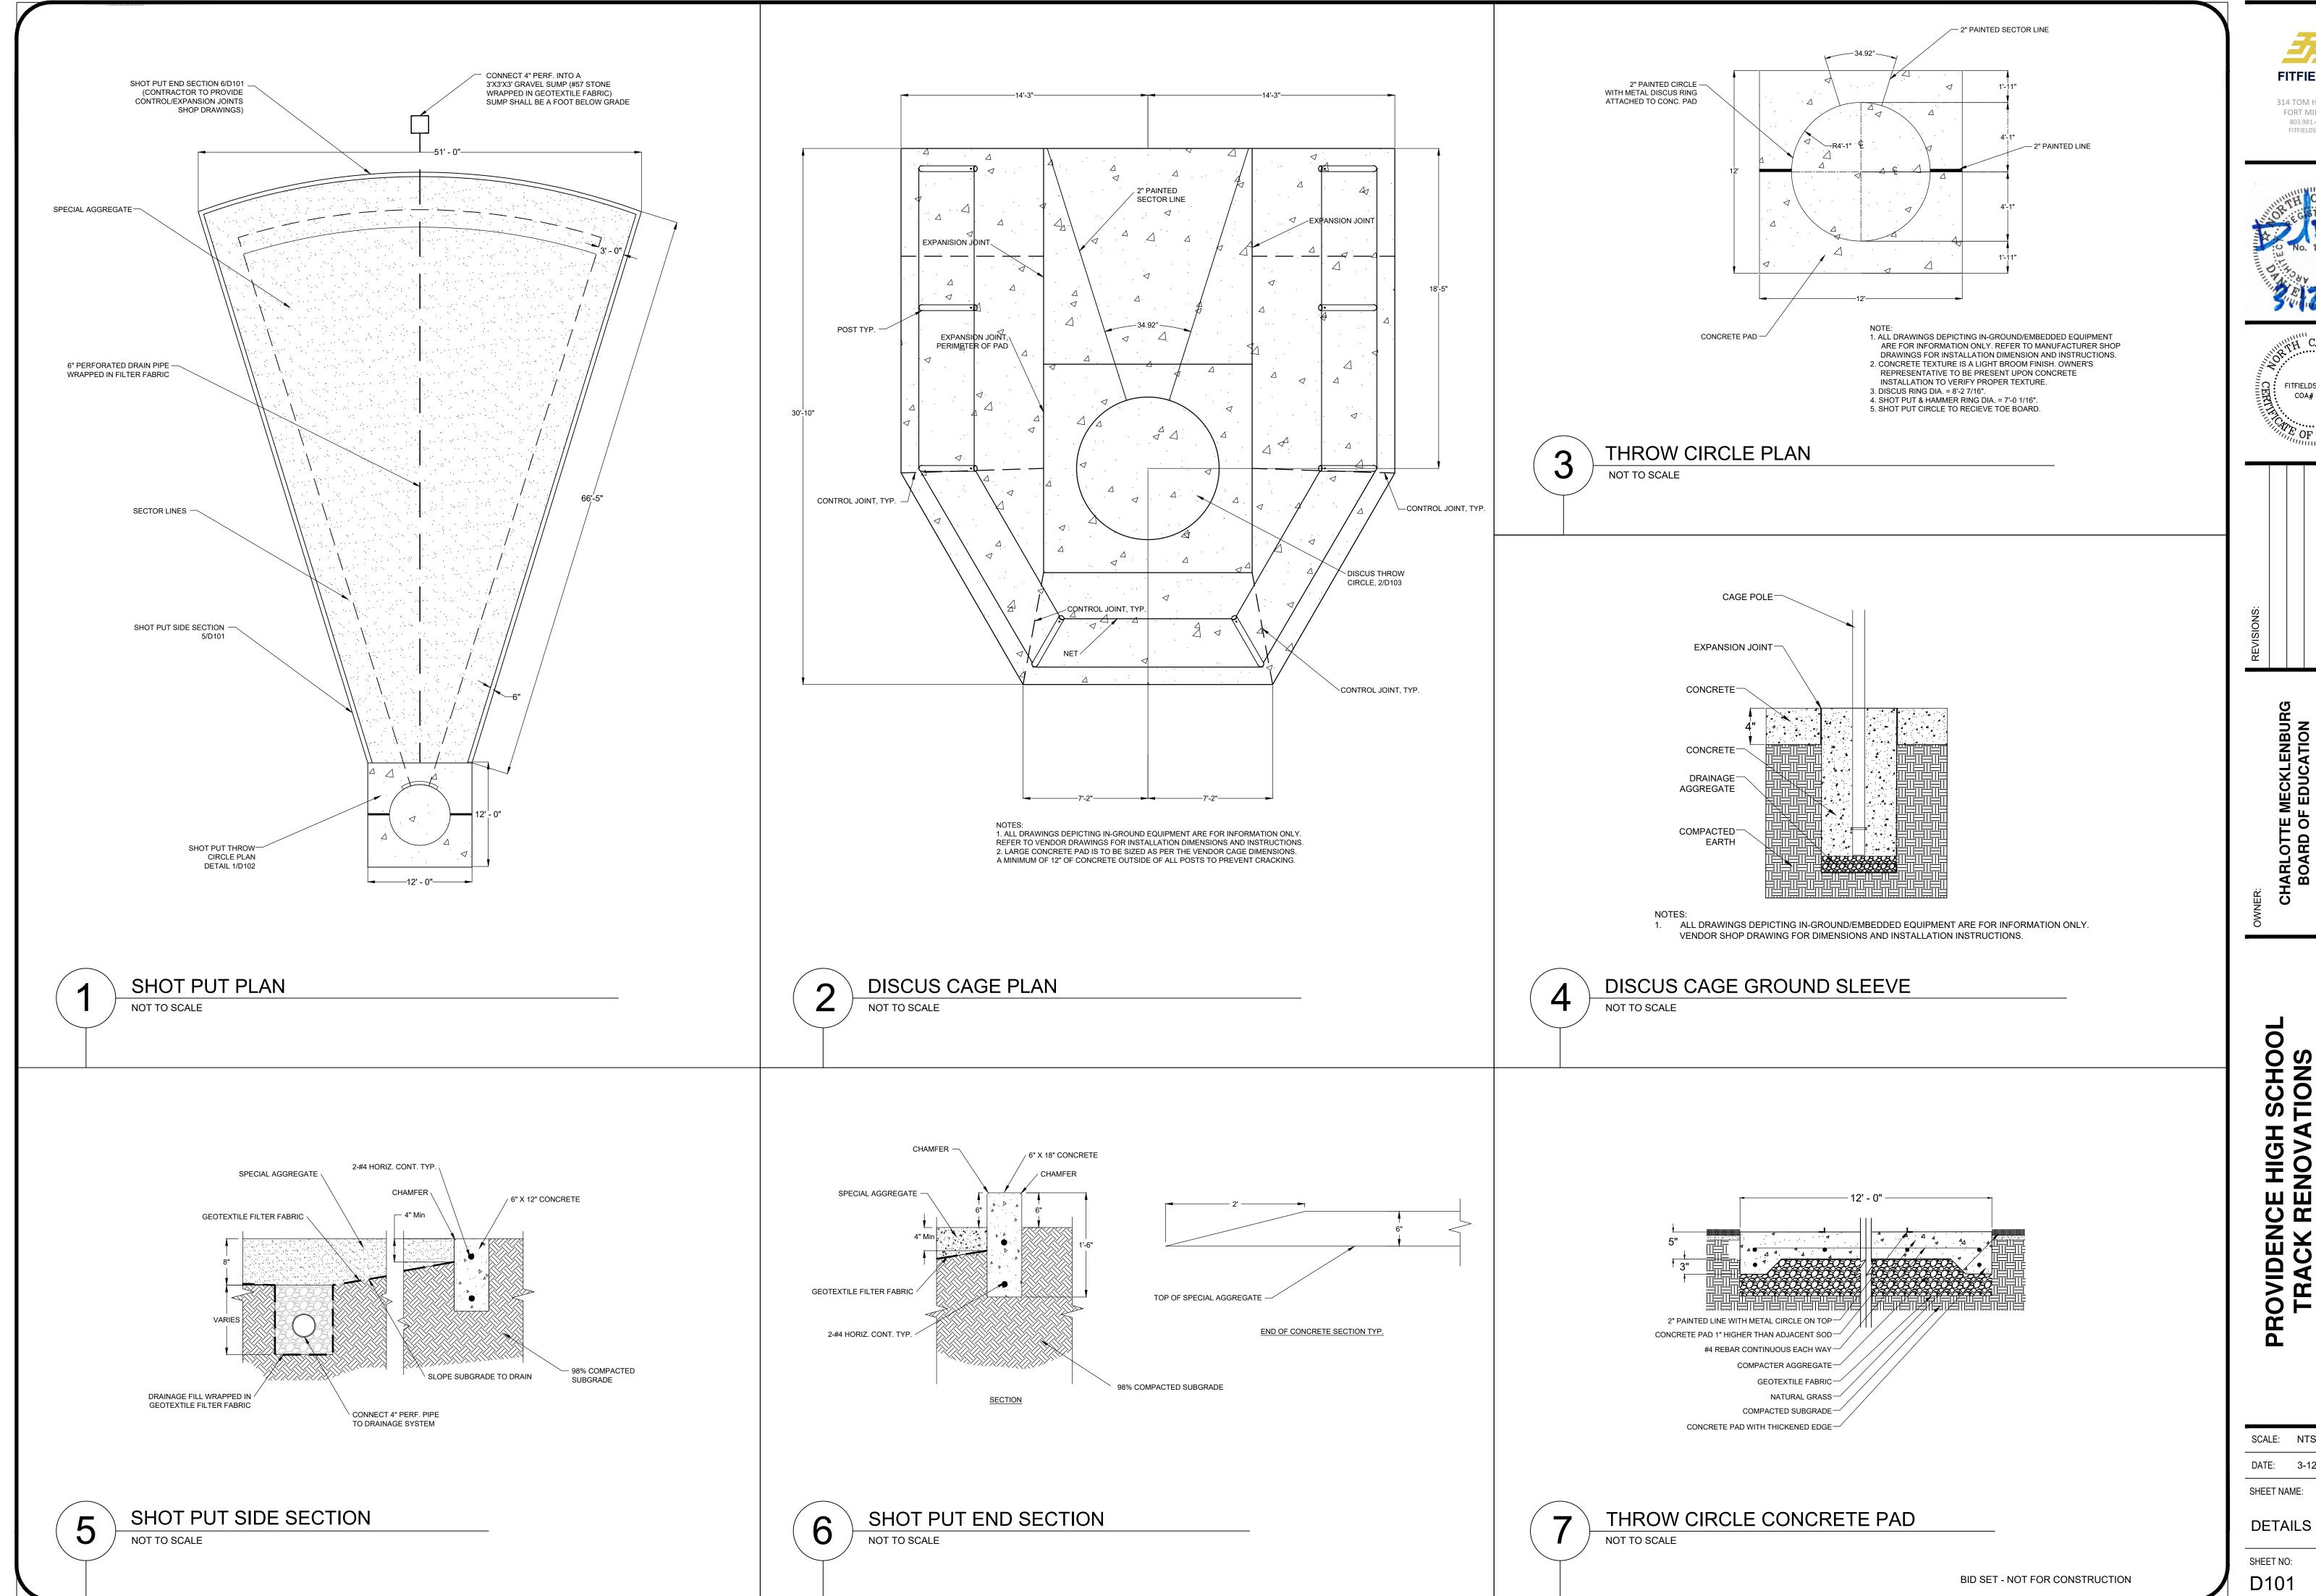
SHEET NAME:

LONG/TRIPLE JUMP SAND PIT SECTION

DETAILS

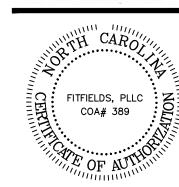
SHEET NO:

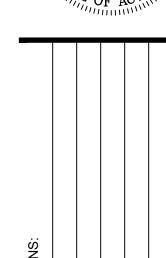
BID SET - NOT FOR CONSTRUCTION



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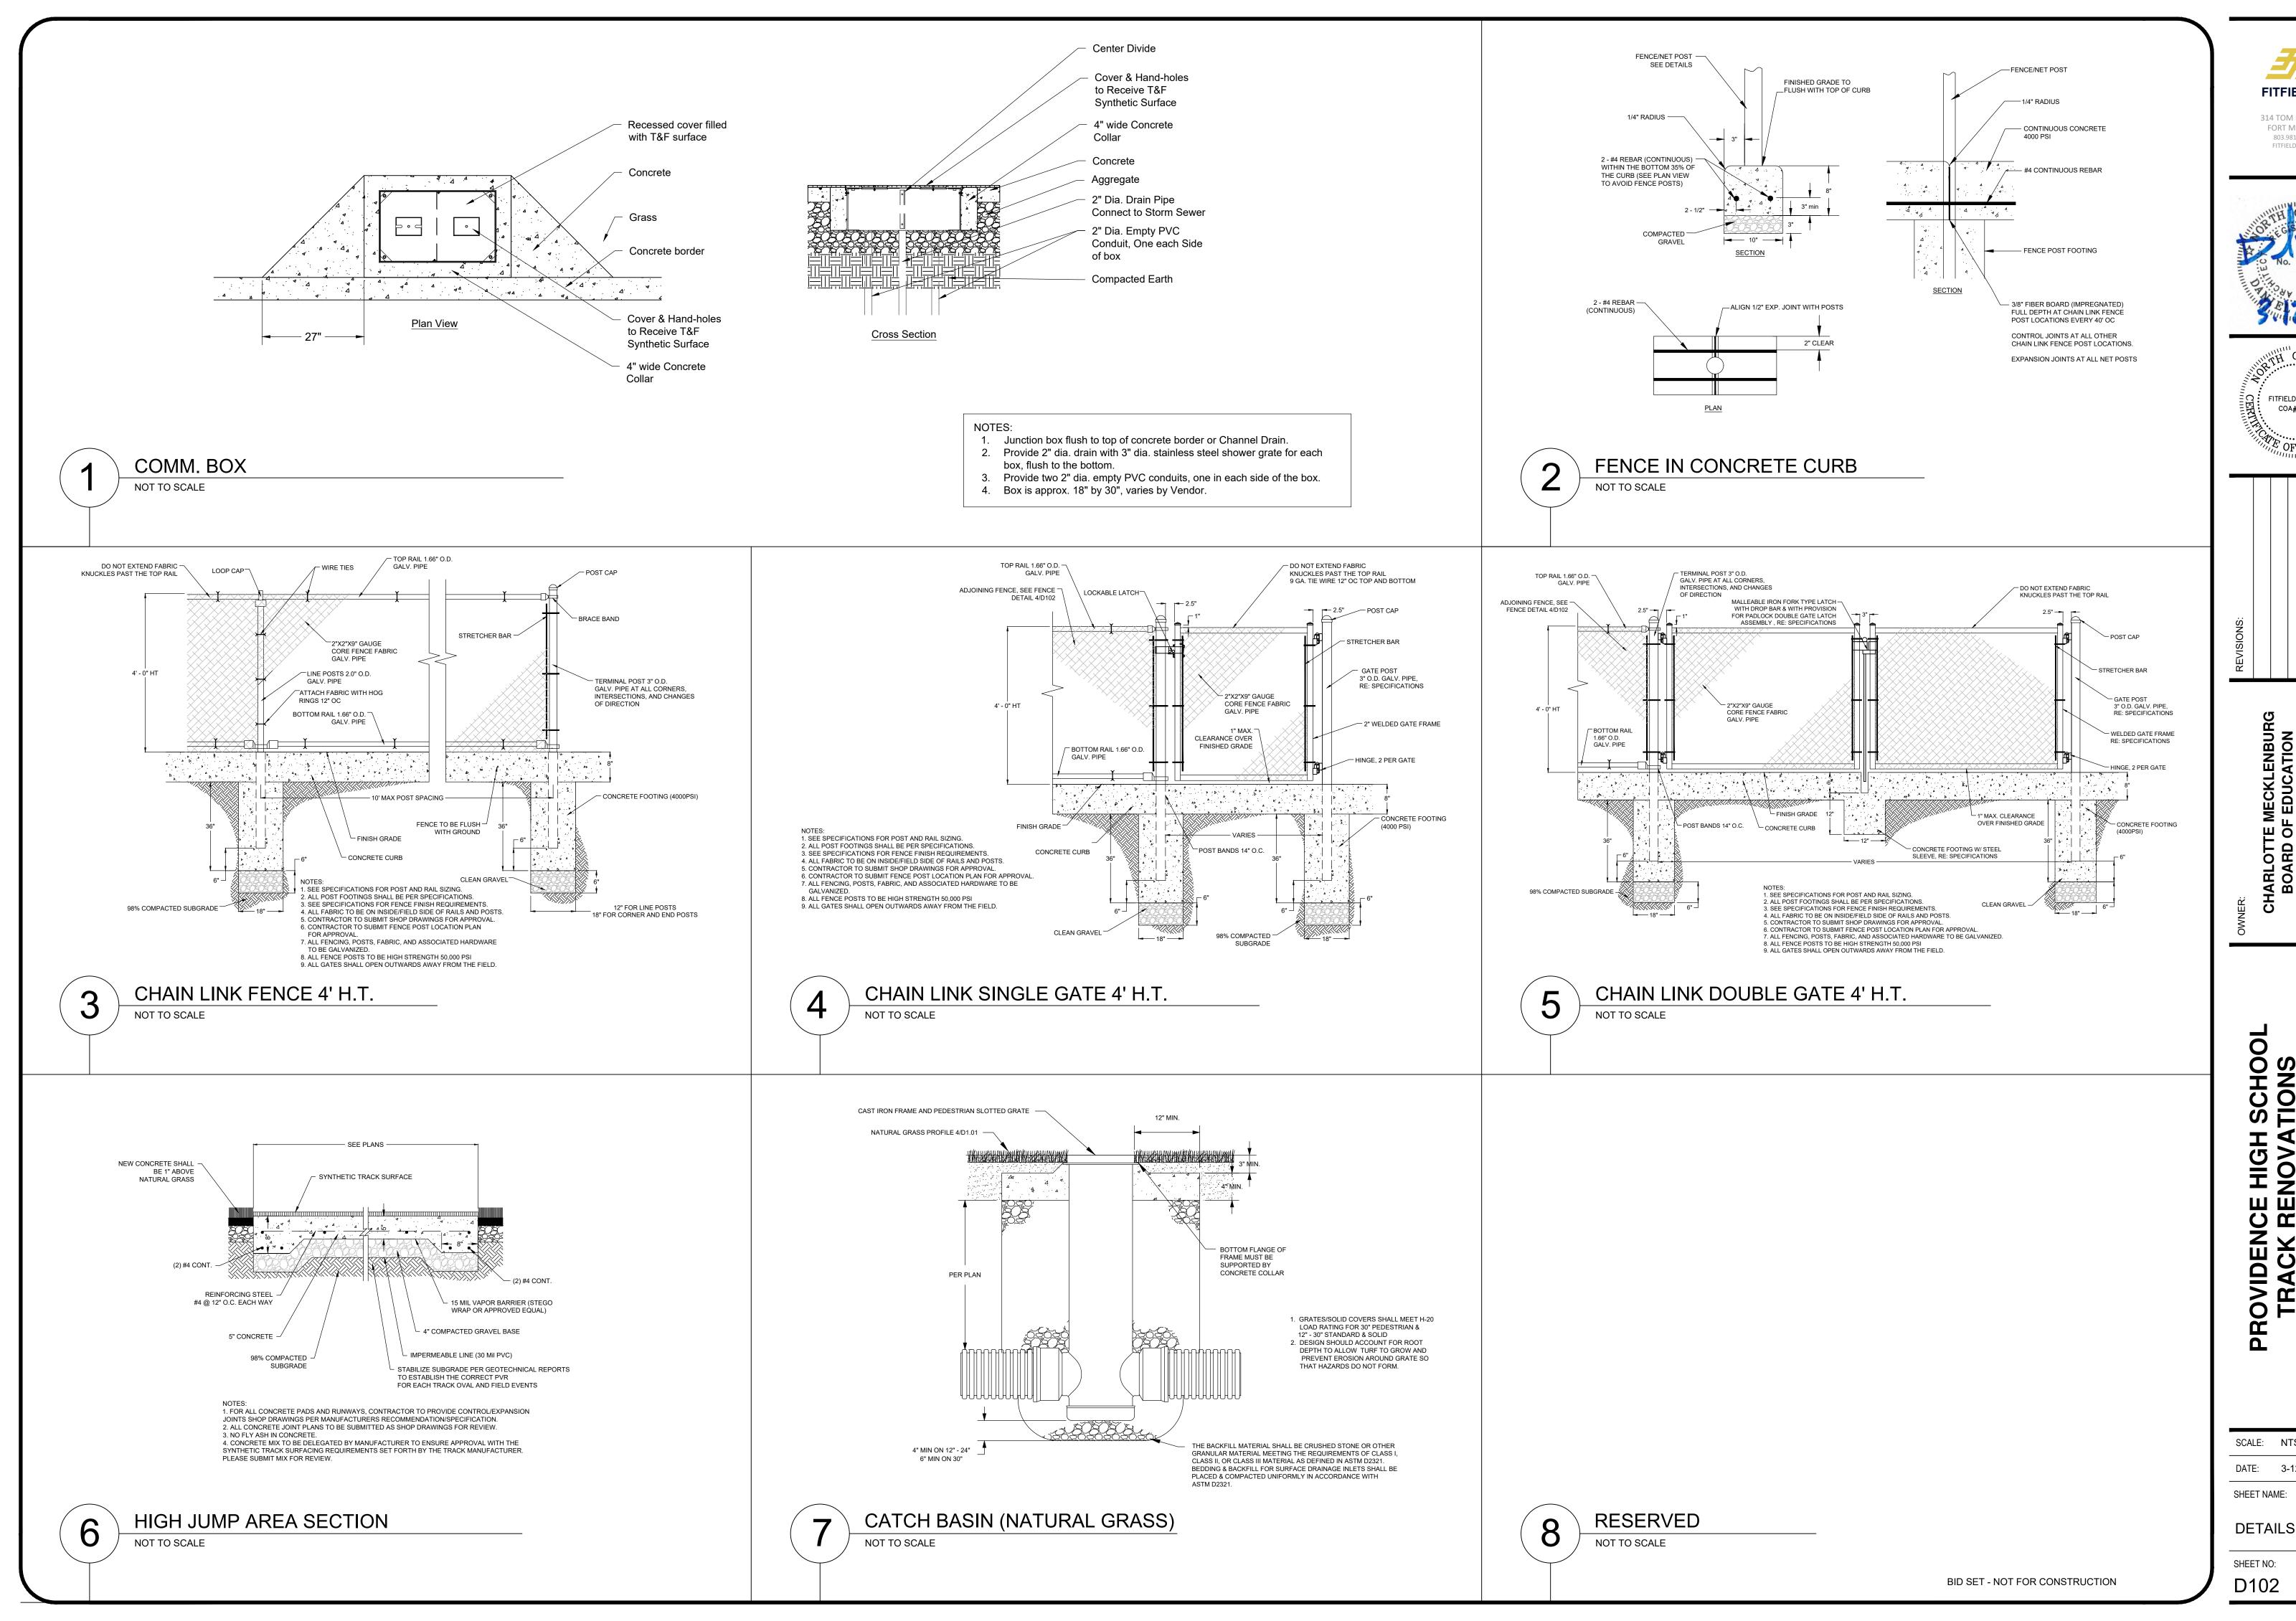







SCALE: NTS DATE: 3-12-25

SHEET NAME:



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SCALE: NTS DATE: 3-12-25

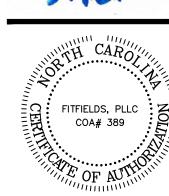SHEET NAME: